ADDENDUM: Number 01

DATE: December 27, 2022

TO: Interested Bidders

CLIENT: Washington Elementary School District

Phoenix, Arizona

PROJECT: Moon Mountain Elementary School Roofing Improvements

SITE: Moon Mountain Elementary School

Phoenix, Arizona

ARCHITECT: Architechnology, Inc.

5229 North 7th Avenue, Suite 101

Phoenix, Arizona 85013

AT PROJECT NO: 21-170

1. INSTRUCTIONS


1. This supplement to Bid Documents is issued prior to the receipt of bids. All Work covered in the supplement shall be included in the original quotation and the Supplement will be considered an integral part of the Contract Documents.

Architechnology

2. All work performed under this Supplement shall be subject to the General Conditions of the Contract and the Specifications for similar work in connection with this Project.



- A. General Items No changes.
- B. Addendum Drawings. Change
 - a. Delete Bid Drawings, dated 8.14.2021 and replace with Addendum No. 01 Drawings, dated 12.27.2022.
- C. Addendum Specifications. No changes.

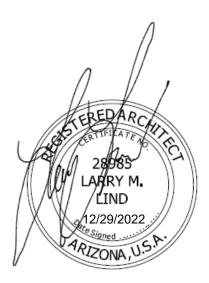

WASHINGTON ELEMENTARY SCHOOL DISTRICT



ROOFING IMPROVEMENTS MOON MOUNTAIN ELEMENTARY SFB PROJECT NO.: BRG DSGN-00410

13425 NORTH 19th AVENUE PHOENIX, ARIZONA 85029






FAX: 602.234.1561



reference site plan

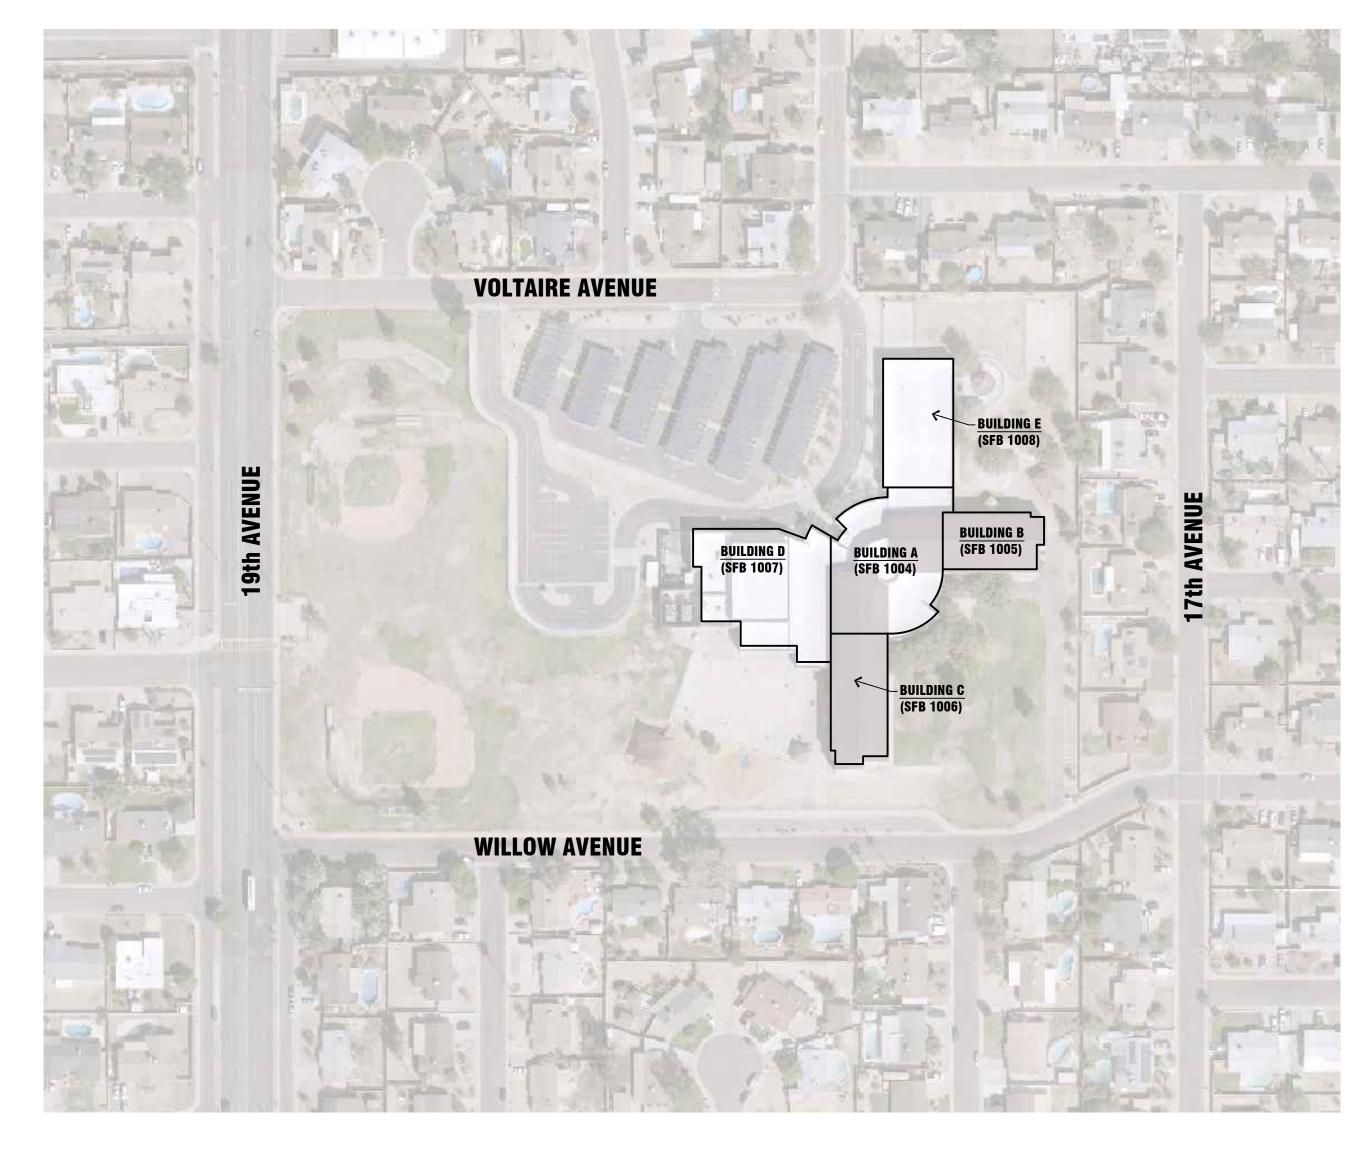

general notes

abbreviations

A.F.F.

AGGR.

ALT.

APPROX.

ARCH.

BLDG.

BLK'G

BLK.

BOT.

BTWN.

B.U.R.

B.W.

C.J.

CLG.

CLR.

COL.

CONC.

CONT.

C.T.

DEG.

DIAG.

DIA.

DN.

DS.

DWG.

EL. / ELEV.

ELEC.

EMER.

ENCL.

EQUIP.

E.W.C. EXP.

E.W.

EXT.

F.A.

F.D.

F.D.C.

F.E.

F.E.C.

F.H.C.

FIN.

F.L.

FLR.

FND.

F.O.B.

F.O.C.

F.S.

FTG.

GA.

G.C.

GR.

H.B.

H.C.

H/C

HDWD.

HDWE

H.M.

HR.

HT.

GYP.

GYP. BD.

FURR.

FT.

FLOUOR.

F.F.

EQ.

CONSTR

CMU

CLKG.

ACOUSTICAL CEILING TILE

ABOVE FINISHED FLOOR

AGGREGATE

ALUMINUM

ALTERNATE

BUILDING

BLOCKING

BOTTOM

BETWEEN

CEILING

CAULKING

COLUMN

CONCRETE

CONSTRUCTION

DRINKING FOUNTAIN

CONTINUOUS

CARPET TILE

DEGREE

DIAGONAL

DIAMETER

DOWNSPOU

DRAWING

EXISTING

ELEVATION

ELECTRICAL

EMERGENCY

ENCLOSURE

EQUIPMENT

ELECTRIC WATER COOLER

FIRE DEPARTMENT CONNECTION

FIRE EXTINGUISHER CABINET

EACH WAY

EXPANSION

FIRE ALARM

FLOOR DRAIN

FINISH FLOOR

FINISH

FLOOR

FULL SIZE

FOOTING

FURRING

GAUGE

GLASS

GRADE

GYPSUM

HOSE BIB

FLOW LINE

FLUORESCENT

FOUNDATION

FOOT OR FEET

GALVANIZED

GYPSUM BOARD

HOLLOW CORE

HANDICAPPED

HARDWOOD

HOLLOW METAL

HARDWARE

HOUR

HEIGHT

GENERAL CONTRACTOR

FACE OF BRICK

FACE OF CONCRETE

FIRE EXTINGUISHER

FIRE HOSE CABINET

EXTERIOR

EXPANSION JOINT

EXTERIOR INSULATION & FINISH SYSTEM

EACH

DOWN

DET. / DETL. DETAIL

BOTH WAYS

CONTROL JOINT

BUILT UP ROOFING

CONCRETE MASONRY UNIT

BLOCK

BEAM

APPROXIMATE

ARCHITECTURAL

INSUL.

INT.

JAN.

JST.

KIT

LAB.

LAM.

LAV.

MAX.

MECH.

MEMB.

MFR.

M.H.

MIN.

M.O.

MTL.

MUL.

N.I.C.

NO.

O.C.

O.D.

OH.

OPG.

OPP.

PCT.

PLAM.

PLYWD.

R.D.

REFR.

RM

REQ'D

SCHED.

SHT.

SPEC.

STAGG.

STD.

STIFF.

STL.

STRUC.

SUSP.

T & B

T & G

TFR.

TYP.

VER.

W/

W.C.

WD.

W/O

VERT.

TR.

SQ.

S.S.

INSULATION

INTERIOR

JOINT

JOIST

KITCHEN

LABORATORY

LAMINATE

LAVATORY

MAXIMUM

MECHANICAL

MEMBRANE

MANHOLE

MINIMUM

METAL

NORTH

MULLION

NUMBER **NOMINAL**

MANUFACTURER

MISCELLANEOUS

MASONRY OPENING

NOT IN CONTRACT

OUTSIDE DIAMETER

PLASTIC LAMINATE

NOT TO SCALE

ON CENTER

OVERHEAD

OPENING

OPPOSITE

PRE-CAST PROPERTY LINE

PLASTER

RISER

ROOF DRAIN

REFRIGERATOR

ROUGH OPENING

REFER TO

REQUIRED

ROOM

SOUTH

SOLID CORE

SQUARE FOOT

SPECIFICATION

STAINLESS STEEL

STAGGERED

STANDARD

STIFFENER

STRUCTURAL

SUSPENDED

TERRAZZO

TOP AND BOTTOM

TONGUE AND GROOVE

VINYL COMPOSITION TILE

STEEL

READ

THICK

TOP OF

TYPICAL

VERTICAL

WATER CLOSET

WEST

WITH

WOOD

WITHOUT

SCHEDULE

SECTION

SHEET

SIMILAR

SQUARE

PLYWOOD

LIGHT

- A. THE CONTRACTOR SHALL COMPLY WITH ALL APPLICABLE CODES, LAWS, AND ORDINANCES HAVING JURISDICTION ON THIS PROJECT.
- B. ALL OMISSIONS AND CONFLICTS BETWEEN THE VARIOUS ELEMENTS OF THE CONTRACT DOCUMENTS SHALL BE BROUGHT TO THE ATTENTION OF THE ARCHITECT AND RESOLVED PRIOR TO PROCEEDING WITH ANY CONSTRUCTION
- C. THE CONTRACTOR SHALL VERIFY ALL EXISTING DIMENSIONS, CLEARANCES, AND CONDITIONS. ANY DISCREPANCIES OR CONFLICTS SHALL BE REPORTED TO THE ARCHITECT PRIOR TO COMMENCEMENT OF WORK.
- D. WE CERTIFY TO THE BEST OF OUR KNOWLEDGE, INFORMATION AND BELIEF, THAT THE DESIGN OF THIS PROJECT COMPLIES WITH THE APPLICABLE PROVISIONS & REQUIREMENTS OF SECTION 34-4-1 TO 34-411 INCLUSIVE OF THE STATUTES OF THE STATE OF ARIZONA.
- E. AS PER THE SPECIFICATION SECTION FOR PROJECT CLOSE-OUT, THE ARCHITECT WILL ISSUE A "CERTIFICATE OF SUBSTANTIAL COMPLETION OF THE PROJECT
- F. ANY FUTURE CHANGE OR REVISIONS TO THESE PLANS SHALL BE SUBMITTED TO THE CITY FOR REVIEW, AND APPROVAL PRIOR TO COMMENCING ANY WORK.
- G. ALL CHANGES AND/OR REVISIONS SHALL BE NOTED ON THE PLANS BY "CLOUDING" THE AREAS AFFECTED BY THESE REVISIONS OR CHANGES, AND WITH "DELTAS" INDICATING THE NUMBER OF TIMES THE CHANGES OCCUR. IN ADDITION, THE DATE OF THESE CHANGES OR REVISIONS SHALL BE INDICATED. THIS DATA SHALL ALSO BE PLACED IN THE TITLE BLOCK, IN AN APPROPRIATE BULLETIN OR SCHEDULE.
- H. SEE SPECIFICATIONS FOR PRIOR APPROVALS. IF NO PRIOR APPROVAL IS SUBMITTED THEN BID MUST BE TO ROOF MANUFACTURE SPECIFIED AS "BASIS OF DESIGN"

roofing general notes

- A. ALL NEW ROOF PENETRATIONS TO BE FULLY WATER TIGHT. REPAIR EXISTING METAL FLASHING/FASCIA AS REQUIRED. REFER TO DETAILS.
- B. ROOF AREA NUMBERS ARE SHOWN FOR ROOF AREA LOCATION COMMUNICATION
- C. ALL MECHANICAL UNITS, EXHAUST FANS, MECHANICAL EQUIPMENT, ETC. MOUNTED ON ROOF SHALL BE PROVIDED WITH CRICKETING AS REQUIRED TO PROVIDE POSITIVE ROOF DRAINAGE, TYPICAL.
- D. VERIFY ALL ROOF DECK CONDITIONS PRIOR TO ANY ROOFING ACTIVITIES.
- E. COORDINATE ALL MECHANICAL ROOF MOUNTED EQUIPMENT FOR PROPER CURB REQUIREMENTS AND PENETRATION OPENINGS SO THAT PROPER FLASHING MAY BE INSTALLED AS TO CONFORM WITH THE MANUFACTURER'S STANDARD DETAILS / INSTALLATION REQUIREMENTS.
- NOT ALL PENETRATIONS MAY BE INDICATED. CONTRACTOR TO FIELD VERIFY. FOR TYPICAL VENT AND PIPE PENETRATIONS THROUGH ROOF MEMBRANE,
- G. REFER TO PLANS FOR LOCATIONS OF NEW COPING, GUTTERS, AND ASSOCIATED DETAILS.
- H. ALL SHEET METAL FABRICATIONS TO COMPLY WITH THE LATEST SMACNA ARCHITECTURAL SHEET METAL MANUAL - TYPICAL.
- SIZES, AND LOCATIONS OF MECHANICAL AND ELECTRICAL PENETRATIONS PRIOR TO BIDDING. NO ADDITIONAL COMPENSATION WILL BE ALLOWED FOR ADDITIONAL ROOFING PENETRATIONS NOT INDICATED ON DRAWINGS.

COLOR TO MATCH ADJACENT PARAPET WALLS.

REQUIRED TO PROVIDE SLOPE

. CONTRACTOR IS RESPONSIBLE TO VISIT SITE TO ASCERTAIN THE FULL EXTENT OF THE WORK REQUIRED. NO ADDITIONAL COMPENSATION WILL BE ALLOWED FOR FAILURE TO ASCERTAIN FULL EXTENT OF THE WORK REQUIRED THROUGH VISUAL

PROVIDED IN THE STRUCTURE OF BUILDING OR IF TAPERED INSULATION WILL BE

REMOVE ALL EXISTING PARAPET WALL REGLETS (U.N.O.) EXISTING PARAPET WALL

COUNTER FLASHING AT REGLET TO BE REMOVED FOR INSTALLATION OF NEW ROOF

MEMBRANE. INSTALL NEW COUNTER FLASHING AS REQUIRED TO CONFORM WITH

MANUFACTURES ROOF WARRANTY. PAINT ALL REGLETS AND COUNTER FLASHING

I. MECHANICAL UNITS, EQUIPMENT, VENTS, ETC. SHOWN ARE DIAGRAMMATIC. THEY

ARE NOT TO SCALE AND THE LOCATIONS ARE APPROXIMATE. NOT ALL ROOFING

PENETRATIONS HAVE BEEN SHOWN. CONTRACTOR TO FIELD VERIFY QUANTITIES,

- INSPECTION OF EXISTING CONDITIONS AND THAT DETAILED AND SPECIFIED WITHIN THE CONTRACT DOCUMENTS. ROOF SLOPED INDICATED ARE APPROXIMATE. CONTRACTOR TO VERIFY IF SLOPE IS
- M. CONTRACTOR TO PROVIDE WARRANTED WATER TIGHT ROOF CONSTRUCTION AND FLASHING AT ALL NEW ROOFING INSTALLATIONS EXCEPT AT EXISTING ROOFING TO REMAIN. CONTRACTOR TO VISUALLY INSPECT ALL METAL COPING TO REMAIN FOR POTENTIAL SOURCES OF LEAKS AND PROVIDE REPORT TO ARCHITECT FOR REVIEW.
- N. CONTRACTOR IS RESPONSIBLE FOR INSPECTING INTERIOR ROOF LEADERS TO ENSURE THAT THEY ARE NOT LEAKING. IF LEAKS ARE DISCOVERED, THE CONTRACTOR SHALL NOTIFY THE OWNER AND THE ARCHITECT.

project information

OWNER:

ARCHITECT:

PROJECT NAME: **ROOFING IMPROVEMENTS**

WASHINGTON ELEMENTARY SCHOOL DISTRICT

4650 WEST SWEETWATER

GLENDALE, AZ 85304 PHONE: 602-347-2600

PROJECT SITE: MOON MOUNTAIN ELEMENTARY SCHOOL 13425 N 19TH AVENUE

PHOENIX, AZ 85029

ARCHITECHNOLOGY INC.

LARRY M. LIND, A.I.A. PRINCIPAL ARCHITECT / ROOF CONSULTANT 5229 N. 7TH AVE. STE 101

PHOENIX, ARIZONA 85013 P (602) 347-5226 F (602) 234-1561



washington elementary school district

GOVERNING BOARD: BOARD PRESIDENT - BILL ADAMS

BOARD MEMBER - JENNI ABBOTT-BAYARDI **BOARD MEMBER - TEE LAMBERT**

VICE PRESIDENT - NIKKIE WHALEY

BOARD MEMBER - LINDSEY PETERSON

SUPERINTENDENT: DR. PAUL STANTON

ALL CONSTRUCTION SHALL COMPLY WITH THE FOLLOWING BUILDING CODES AND AMENDMENTS PER THEIR ADOPTING ORDINANCES:

2018 INTERNATIONAL BUILDING CODE 2018 INTERNATIONAL EXISTING BUILDING CODE 2018 INTERNATIONAL RESIDENTIAL CODE 2018 INTERNATIONAL MECHANICAL CODE 2018 INTERNATIONAL FUEL GAS CODE 2018 INTERNATIONAL ENERGY CONSERVATION CODE 2017 NATIONAL ELECTRICAL CODE

2018 UNIFORM PLUMBING CODE 2018 INTERNATIONAL SWIMMING POOL AND SPA CODE

sheet index

G0.0 COVER SHEET

G1.1 PROJECT INFORMATION / REFERENCE SITE PLAN A1.0 OVERALL ROOF PLAN


applicable codes

A1.1 BUILDING E (SFB 1008) ROOF PLAN A1.2 BUILDING A (SFB 1004) ROOF PLAN

A1.3 BUILDING D (SFB 1007) ROOF PLAN

A1.4 BUILDING B (SFB 1005) ROOF PLAN A1.5 BUILDING C (SFB 1006) ROOF PLAN



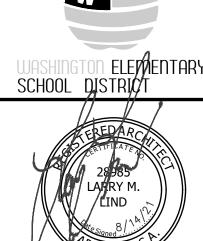

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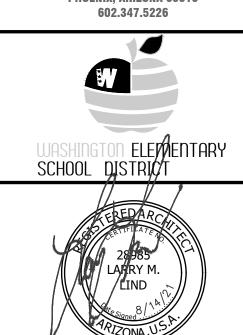
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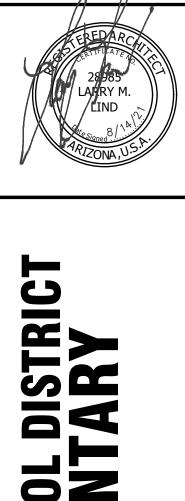
REVIS	COMMENT	DATE	NO.
	ADDENDUM 01	12/27/22	1

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GENERAL INFORMATION REFERENCE SITE PLAN







WASHINGTON ELEMENTARY SCHOOL D
MOON MOUNTAIN ELEMENTA
13425 NORTH 19TH AVE
PHOENIX, ARIZONA 85029
SFB PROJECT NO.: BRG-DSGN-004100

PROJECT NO.:	21170
DRAWN BY:	B. TUTTLE
CHECKED BY:	L. LIND
DATE:	8/14/21

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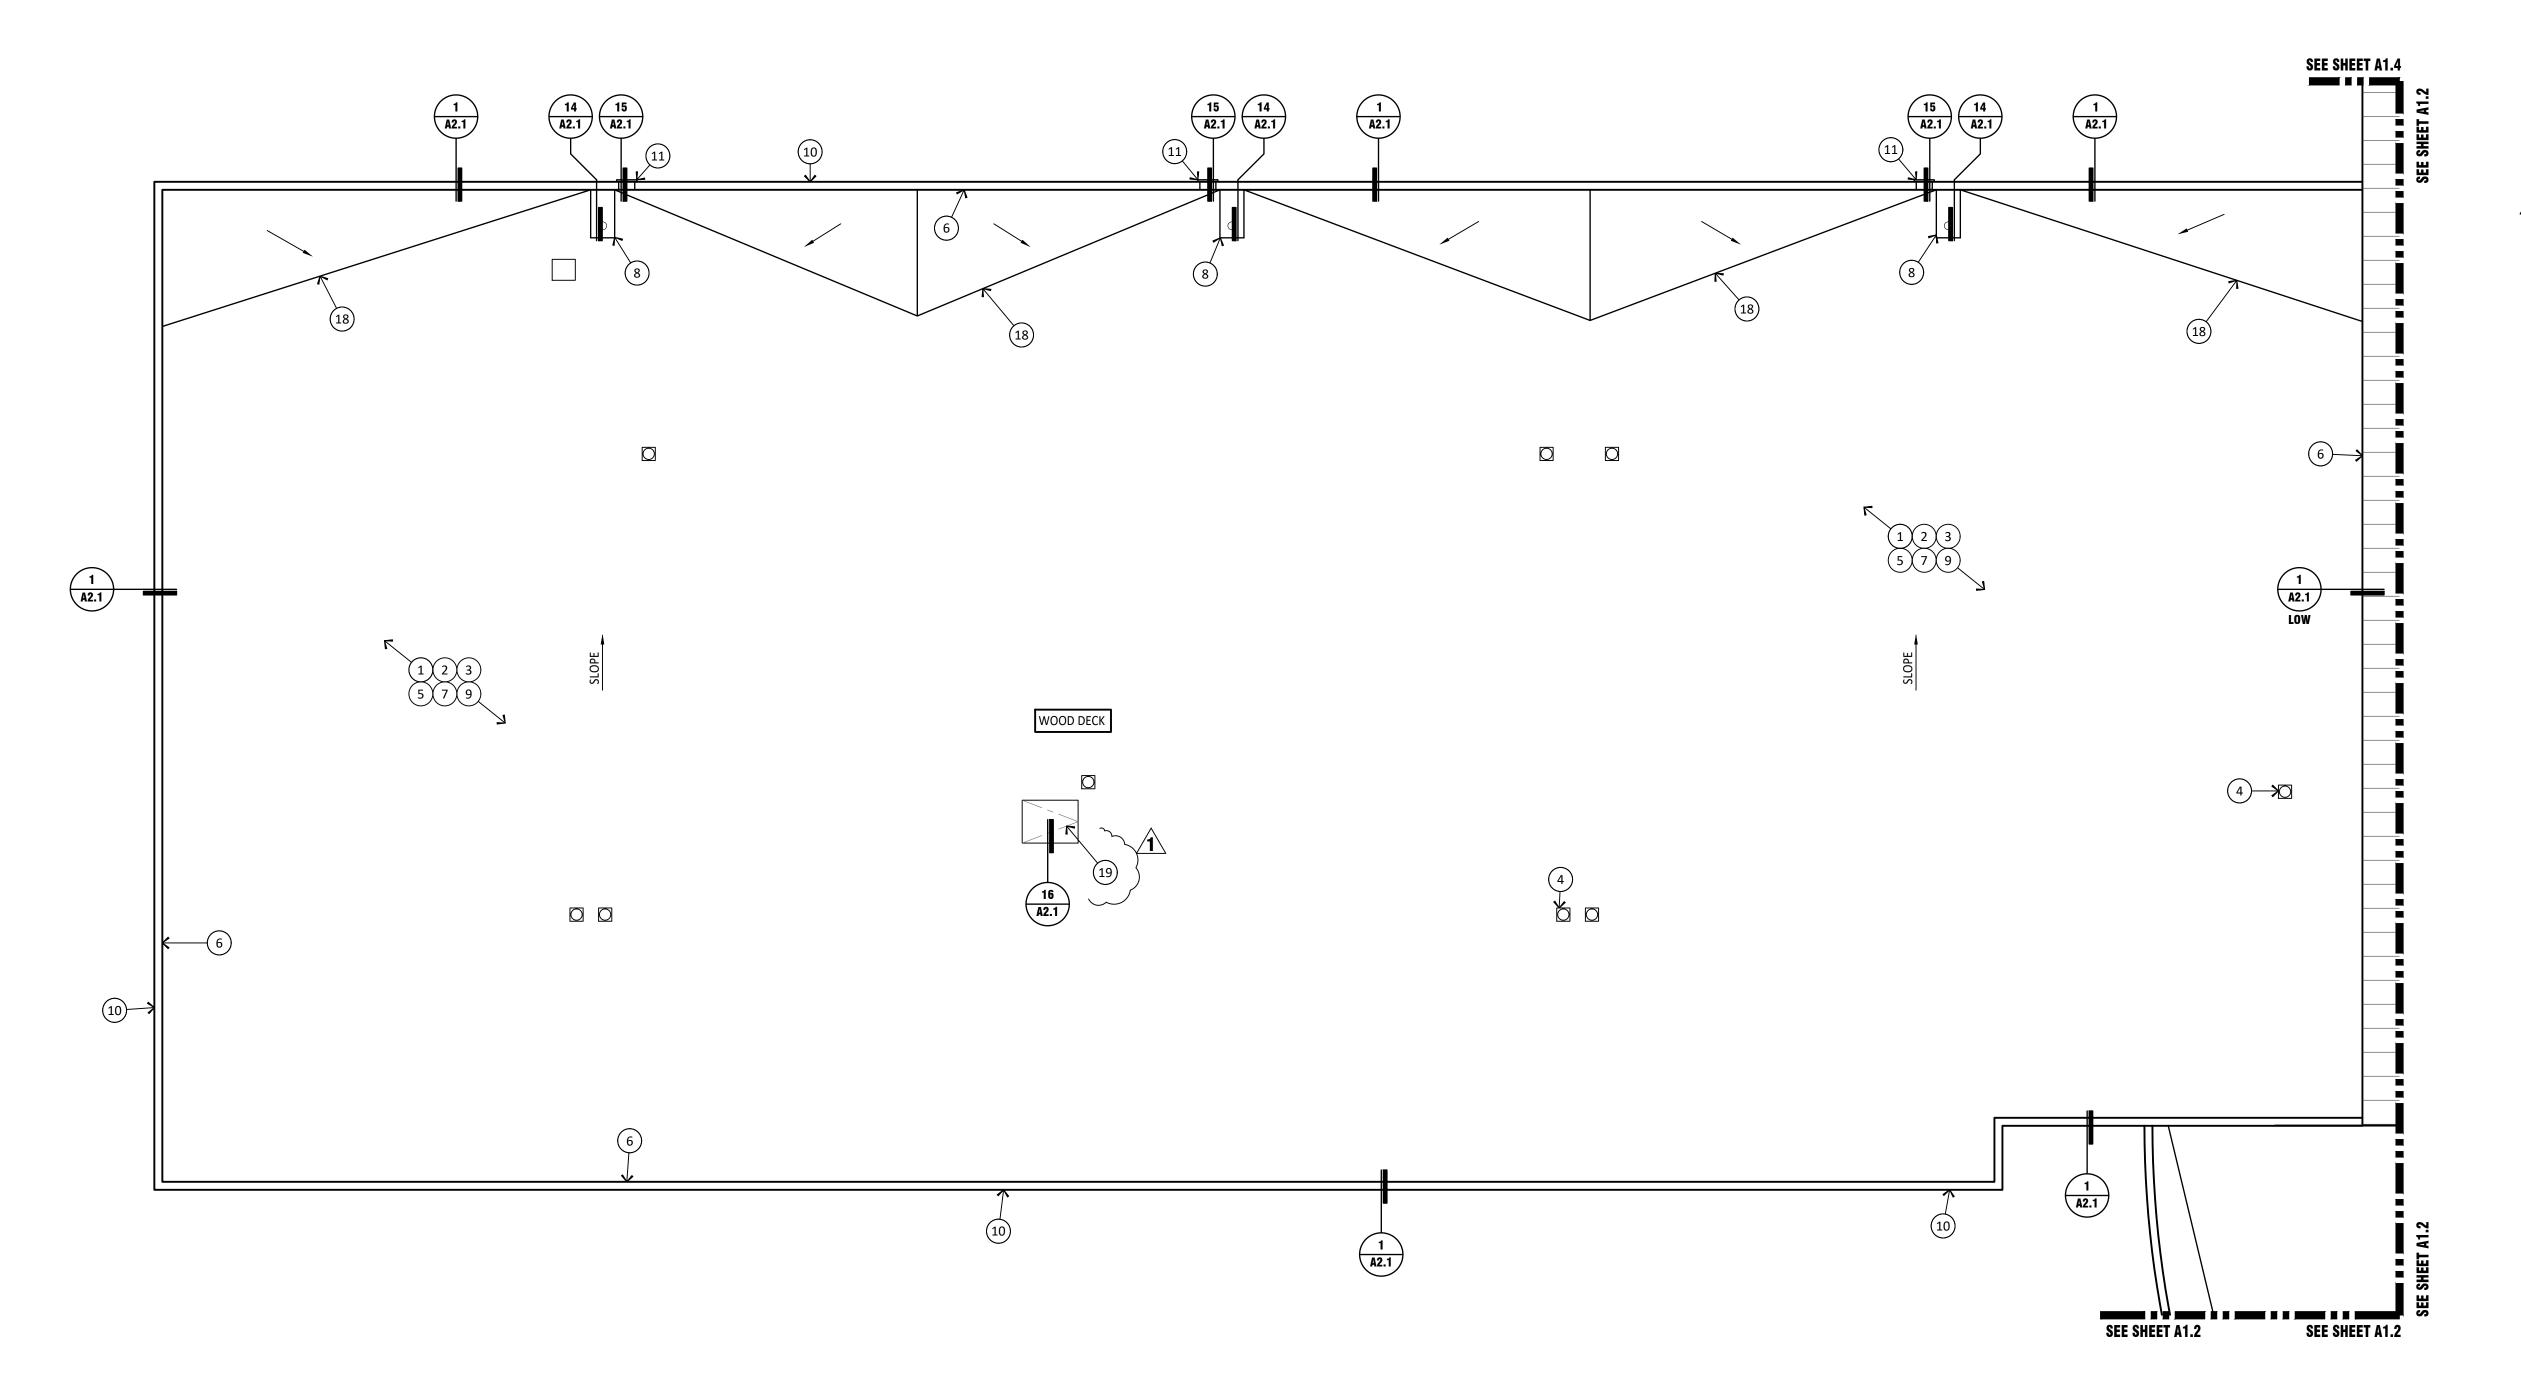
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DRAWING TITLE

MOON MOUNTAIN OVERALL ROOF PLAN

4 0



BUILDING E (SFB 1008) ROOF PLAN

1/8" = 1'-0"

KEYED NOTES

- REMOVE EXISTING ROOFING SYSTEM TO DECK.
 CLEAN AND PREP DECK AS REQUIRED FOR NEW
 ROOF SEE SPECIFICATIONS
- INSTALL NEW ROOFING ON COVER BOARD OVER RIGID INSULATION. TYPICAL SEE SPECIFICATIONS.
- 3. REMOVE AND REPLACE ALL METAL FLASHINGS, REGLETS, AND COUNTER FLASHINGS TYPICAL SEE SPECIFICATIONS.
- 4. PROVIDE NEW FLASHING AT MECHANICAL CURBS. ENSURE CONDENSATE LINES ARE PROPERLY SUPPORTED. REMOVE AND REPLACE DUCT SEALANTS. SEE SPECIFICATIONS TYPICAL
- 5. REMOVE EXISTING SLEEPERS UNDER CONDUIT AND PIPE. PROTECT DURING CONSTRUCTION ACTIVITIES. PROVIDE NEW DURA-BLOK SUPPORTS TYPICAL
- 6. CLEAN EXISTING PARAPET WALLS ON ROOF SIDE. WRAP WALLS 4'-0" HIGH AND UNDER WITH KEE MEMBRANE THAT EXTENDS UP AND OVER NEW TREATED WOOD SLEEPERS. PROVIDE BLOCK FILL AND COAT PARAPET WALLS TALLER THAN 4'-0" TO BOTTOM OF COPING - SEE SPECIFICATIONS
- 7. REMOVE ALL CONSTRUCTION JOINT CAULKING FROM ROOF SIDE OF PARAPET AND REPLACE PER SPECIFICATIONS
- 8. PROVIDE NEW SUMPS AS REQUIRED AT EXISTING SCUPPER LOCATIONS. CLEAR ALL DRAIN LEADERS AND ENSURE PROPER OPERATION SEE SPECIFICATIONS TYPICAL
- 9. RAISE DUCT AS REQUIRED FOR PROPER FLASHING -
- 10. PROVIDE NEW TREATED WOOD NAILERS AND METAL COPING CAPS PER SPECIFICATIONS
- 11. PROVIDE NEW SHEET METAL SCUPPERS
- 12. CLEAR SCUPPERS OF DEBRIS AND ENSURE PROPER OPERATION.
- 13. PROVIDE REPAIRS TO LAPS, SEAMS, RIVETS, PENETRATIONS AND OTHERS AS REQUIRED ON METAL ROOFS. VERIFY IN FIELD. SEE SPECIFICATIONS
- 14. PROVIDE REPAIRS AS REQUIRED VERIFY IN FIELD
- 15. CLEAN ROOF AND PROVIDE NEW COATING SEE SPECIFICATIONS
- 16. CLEAR ROOF DRAINS AND ENSURE PROPER OPERATION
- 17. PROVIDE NEW CONCRETE SPLASH BLOCKS WHERE
- 18. NEW CRICKETS SIZE TO ENSURE PROPER
- 19. PROVIDE NEW ROOF HATCH PROVIDE SUBMITTAL


 - 20. PROVIDE NEW STEEL ROOF ACCESS LADDER PROVIDE SHOP DRAWING TO ARCHITECT SEE DETAIL 1/A1.5
 - 21. REMOVE ALL MECH EQUIPMENT. PROVIDE NEW ROOFING AND FLASHING. REINSTALL ALL EQUIPMENT ON NEW CURB. PROVIDE MECHANICAL, PLUMBING AND MECHANICAL WORK AS REQUIRED TO REMOVE AND REINSTALL SYSTEM. VERIFY PROPER OPERATION AND STARTS UP.

GENERAL NOTES

- A. CONTRACTOR TO REVIEW SPECIFICATIONS PRIOR TO BID. NOTIFY ARCHITECT OF ANY CONFLICTS.
- B. KEYNOTES ARE TYPICAL THROUGHOUT
- C. ANY INCIDENTAL MECHANICAL, PLUMBING OR ELECTRICAL ASSOCIATED WITH ROOFTOP EQUIPMENT SHALL BE PERFORMED BY PROPER LICENSED SUBCONTRACTORS UNDER THIS ROOFING CONTRACT - ALL WORK SHALL BE PERFORMED TO CURRENT CODES
- D. ADJUST EXISTING ELECTRICAL CONDUIT, CONDENSATE AND UTILITY LINES AS REQUIRED FOR NEW ROOF HEIGHT. PROVIDE NEW DURA BLOK SUPPORTS TYPICAL SEE SPECIFICATIONS.
- E. REMOVE EXISTING LOW VOLTAGE WIRE AND REINSTALL AFTER ROOF REPLACEMENT
- F. REMOVE AND PATCH ALL ABANDONED OPENINGS. NOTIFY ARCHITECT IF OPENING IS WIDER THAN 12" X 12"
- G. REMOVE AND REPLACE EXISTING LIGHTNING PROTECTION SYSTEM. NEW SYSTEM TO BE RE CERTIFIED

H. DEMO ALL ABANDONED PITCH PANS. CAP WATER AND POWER TYPICAL DETAILS THROUGHOUT

ITPICAL DEIAIL	<u> 3 IHKOUGHOU</u>
A2.1 PASSIVE VENT	ROOF TOP PIPE SUPPORT
6 EQUIPMENT SUPPORT	A2.1 EXHAUST FAN
9 A2.1 PITCH PAN	13 A2.1 HEAT STACK
8 A2.1 EXPANSION JOINT	A2.1 AREA DIVIDER
9 PITCH POCKET	PRE MANUFACTURE SUPPORT CURB
PIPE PENETRATION	(16) COPING

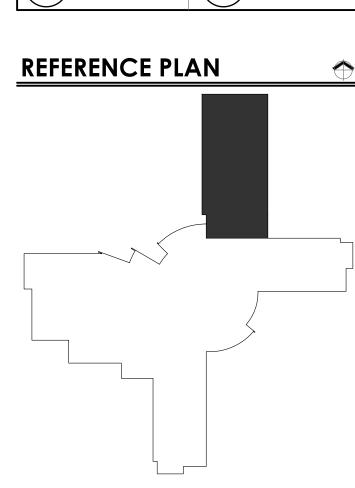

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PROJECT NO.: 21170 DRAWN BY: B. TUTTLE CHECKED BY: L. LIND

NO. DATE COMMENT

12/27/22 ADDENDUM 01

8/14/21

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BUILDING E

(SFB 1008)

ROOF PLAN

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DRAWING TITLE

DATE:

Architechnology

ARCHITECTURE - FACILITIES - C.M. 5229 N. 7th AVE. #101 PHOENIX, ARIZONA 85013

602.347.5226


SCHOOL DISTRICT

n elementary

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SG



BUILDING A (SFB 1004) ROOF PLAN

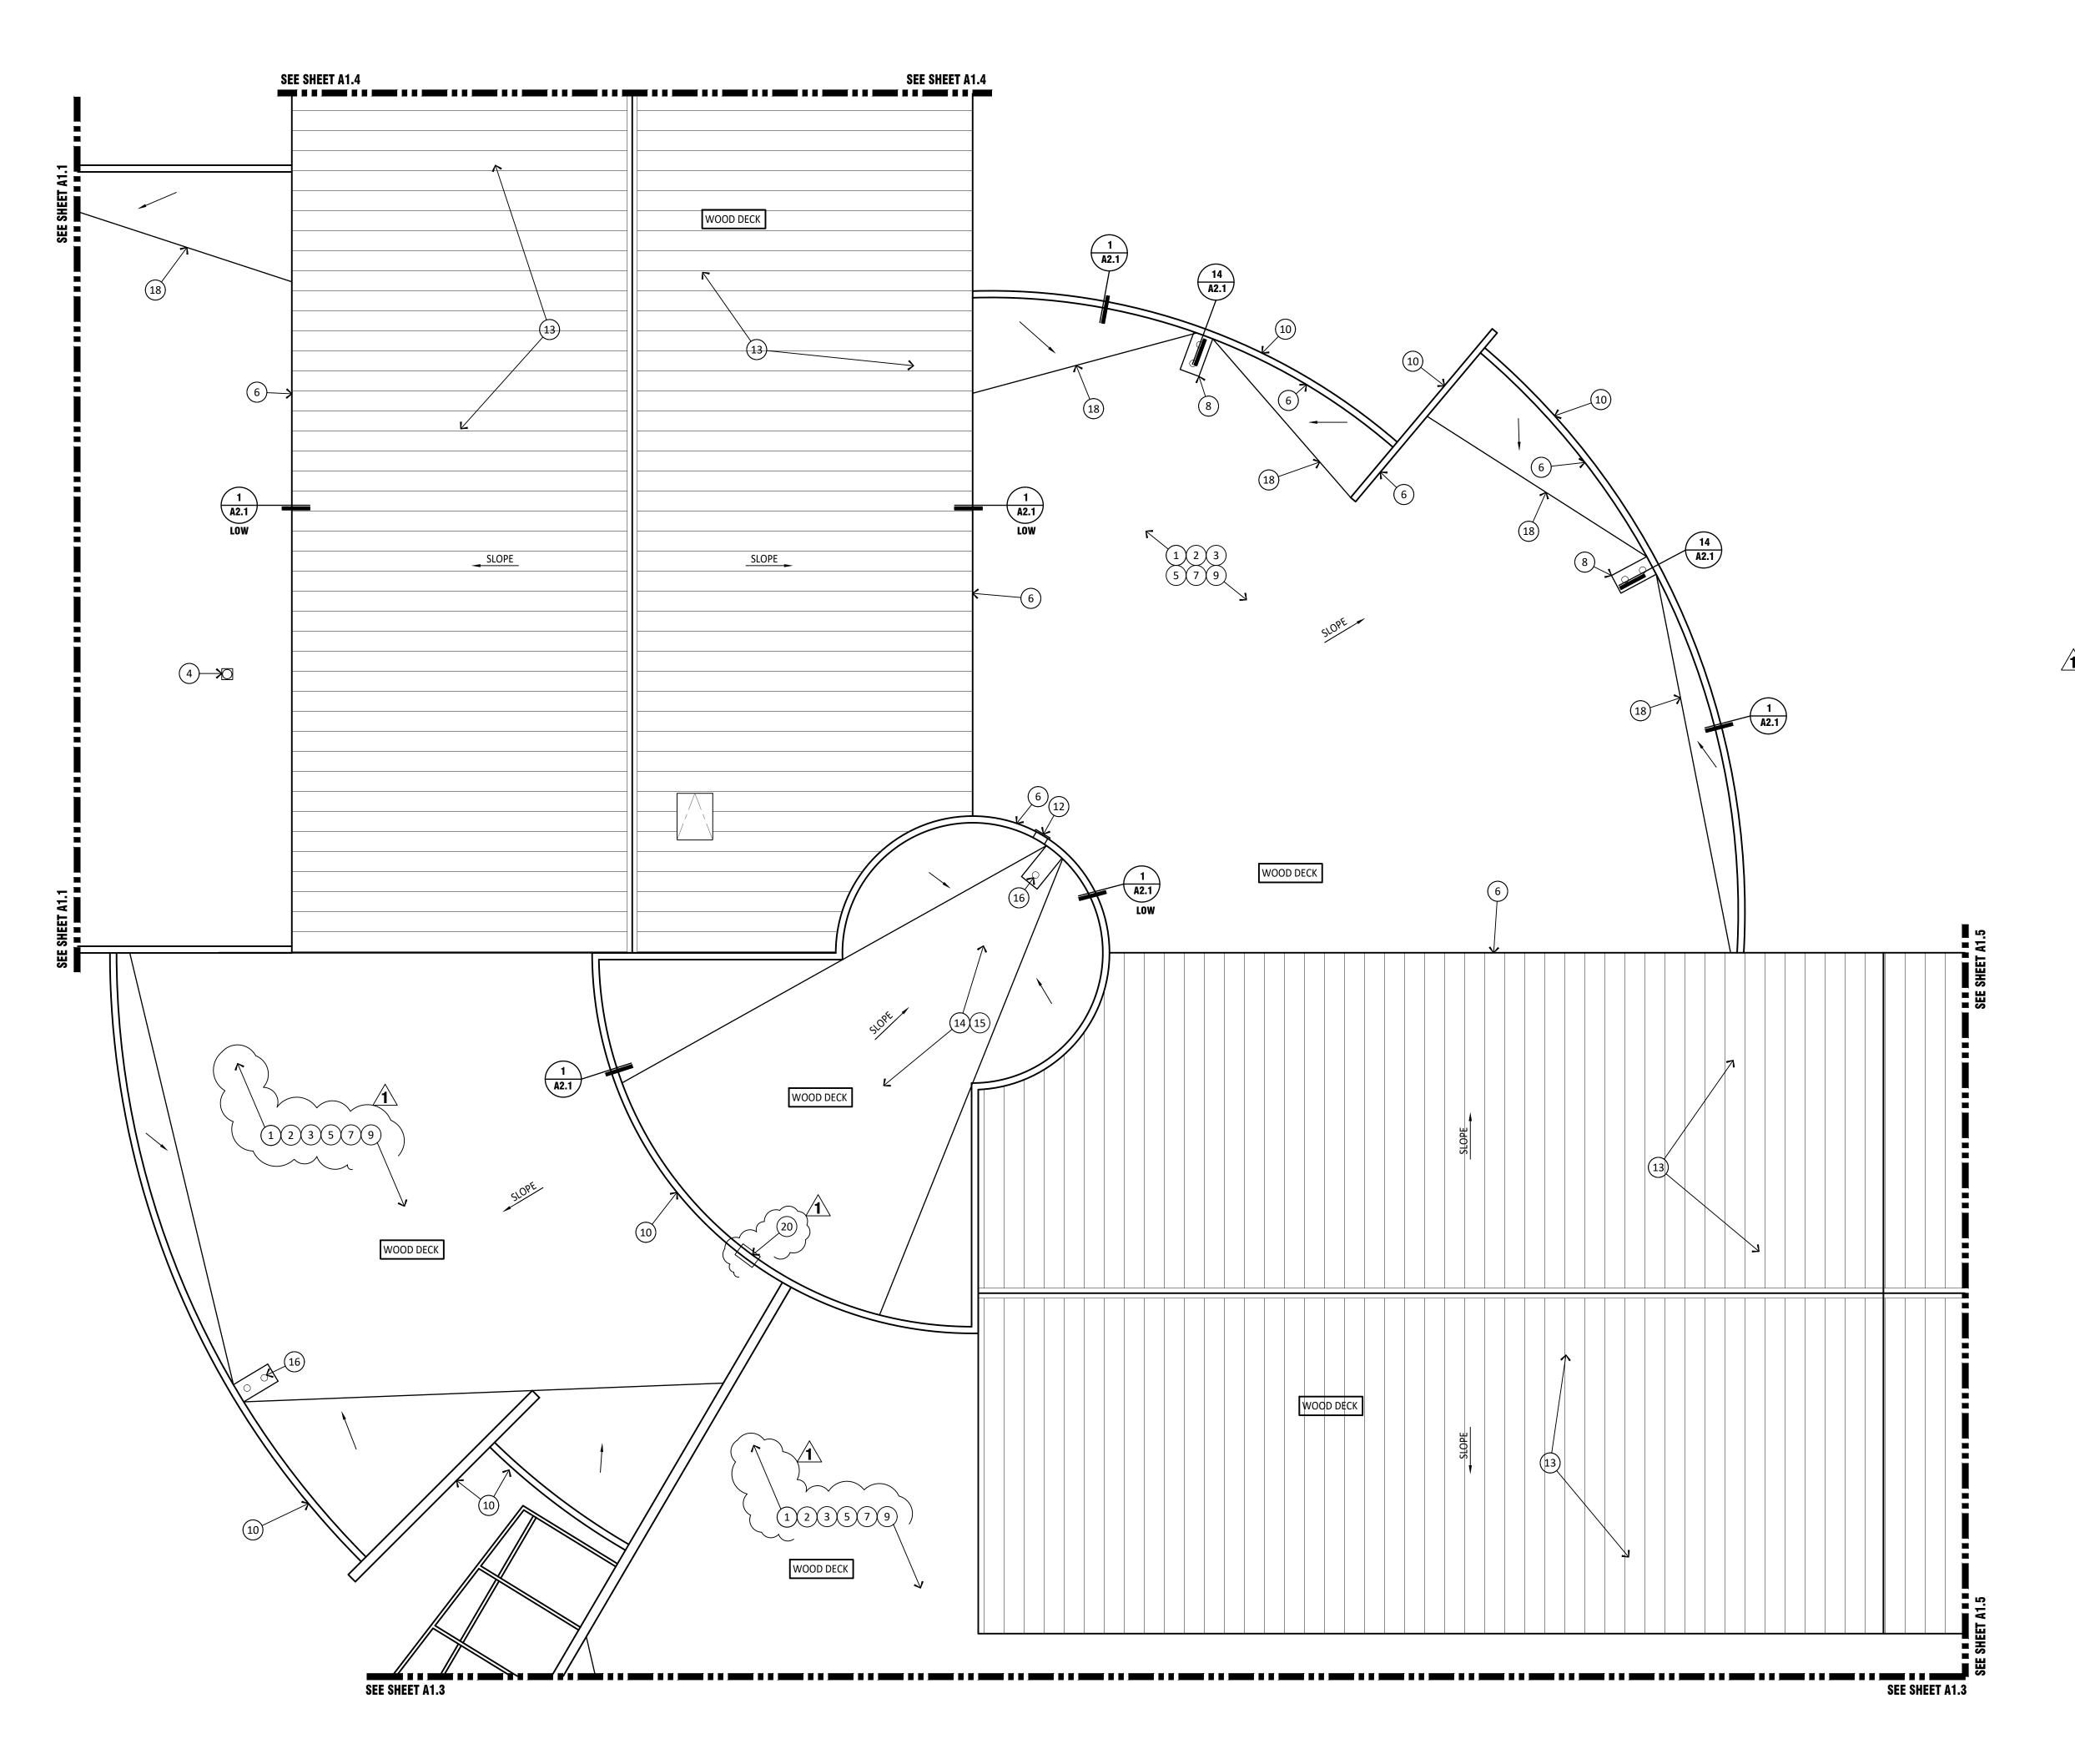KEYED NOTES

- REMOVE EXISTING ROOFING SYSTEM TO DECK. CLEAN AND PREP DECK AS REQUIRED FOR NEW ROOF SEE SPECIFICATIONS
- 2. INSTALL NEW ROOFING ON COVER BOARD OVER RIGID INSULATION. TYPICAL SEE SPECIFICATIONS.
- 3. REMOVE AND REPLACE ALL METAL FLASHINGS, REGLETS, AND COUNTER FLASHINGS TYPICAL SEE SPECIFICATIONS.
- 4. PROVIDE NEW FLASHING AT MECHANICAL CURBS. ENSURE CONDENSATE LINES ARE PROPERLY SUPPORTED. REMOVE AND REPLACE DUCT SEALANTS. SEE SPECIFICATIONS TYPICAL
- 5. REMOVE EXISTING SLEEPERS UNDER CONDUIT AND PIPE. PROTECT DURING CONSTRUCTION ACTIVITIES. PROVIDE NEW DURA-BLOK SUPPORTS TYPICAL
- 6. CLEAN EXISTING PARAPET WALLS ON ROOF SIDE. WRAP WALLS 4'-0" HIGH AND UNDER WITH KEE MEMBRANE THAT EXTENDS UP AND OVER NEW TREATED WOOD SLEEPERS. PROVIDE BLOCK FILL AND COAT PARAPET WALLS TALLER THAN 4'-0" TO BOTTOM OF COPING - SEE SPECIFICATIONS
- 7. REMOVE ALL CONSTRUCTION JOINT CAULKING FROM ROOF SIDE OF PARAPET AND REPLACE PER SPECIFICATIONS
- 8. PROVIDE NEW SUMPS AS REQUIRED AT EXISTING SCUPPER LOCATIONS. CLEAR ALL DRAIN LEADERS AND ENSURE PROPER OPERATION SEE SPECIFICATIONS TYPICAL
- 9. RAISE DUCT AS REQUIRED FOR PROPER FLASHING -
- 10. PROVIDE NEW TREATED WOOD NAILERS AND METAL COPING CAPS PER SPECIFICATIONS
- 11. PROVIDE NEW SHEET METAL SCUPPERS
- 12. CLEAR SCUPPERS OF DEBRIS AND ENSURE PROPER OPERATION.
- 13. PROVIDE REPAIRS TO LAPS, SEAMS, RIVETS, PENETRATIONS AND OTHERS AS REQUIRED ON METAL ROOFS. VERIFY IN FIELD. SEE SPECIFICATIONS
- 14. PROVIDE REPAIRS AS REQUIRED VERIFY IN FIELD
- 15. CLEAN ROOF AND PROVIDE NEW COATING SEE SPECIFICATIONS
- 16. CLEAR ROOF DRAINS AND ENSURE PROPER OPERATION
- 17. PROVIDE NEW CONCRETE SPLASH BLOCKS WHERE
- 18. NEW CRICKETS SIZE TO ENSURE PROPER DRAINAGE
- 19. PROVIDE NEW ROOF HATCH PROVIDE SUBMITTAL 20. PROVIDE NEW STEEL ROOF ACCESS LADDER PROVIDE SHOP DRAWING TO ARCHITECT SEE
- 21. REMOVE ALL MECH EQUIPMENT. PROVIDE NEW ROOFING AND FLASHING. REINSTALL ALL EQUIPMENT ON NEW CURB. PROVIDE MECHANICAL, PLUMBING AND MECHANICAL WORK AS REQUIRED TO REMOVE AND REINSTALL SYSTEM. VERIFY PROPER OPERATION AND STARTS UP.


GENERAL NOTES

DETAIL 1/A1.5

- A. CONTRACTOR TO REVIEW SPECIFICATIONS PRIOR TO BID. NOTIFY ARCHITECT OF ANY CONFLICTS.
- B. KEYNOTES ARE TYPICAL THROUGHOUT
- C. ANY INCIDENTAL MECHANICAL, PLUMBING OR ELECTRICAL ASSOCIATED WITH ROOFTOP EQUIPMENT SHALL BE PERFORMED BY PROPER LICENSED SUBCONTRACTORS UNDER THIS ROOFING CONTRACT - ALL WORK SHALL BE PERFORMED TO CURRENT CODES
- D. ADJUST EXISTING ELECTRICAL CONDUIT, CONDENSATE AND UTILITY LINES AS REQUIRED FOR NEW ROOF HEIGHT. PROVIDE NEW DURA BLOK SUPPORTS TYPICAL SEE SPECIFICATIONS.
- E. REMOVE EXISTING LOW VOLTAGE WIRE AND REINSTALL AFTER ROOF REPLACEMENT
- F. REMOVE AND PATCH ALL ABANDONED OPENINGS. NOTIFY ARCHITECT IF OPENING IS WIDER THAN 12' X 12"
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TIPICAL DETAIL	.3 INKOUGHOU
A2.1 PASSIVE VENT	ROOF TOP PIPE SUPPORT
6 EQUIPMENT SUPPORT	12 A2.1 EXHAUST FAN
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8 A2.1 EXPANSION JOINT	A2.1 AREA DIVIDER
9 PITCH POCKET	PRE MANUFACTURES SUPPORT CURB
PIPE PENETRATION	(16) COPING



PROJECT NO.: 21170 DRAWN BY: B. TUTTLE CHECKED BY: L. LIND

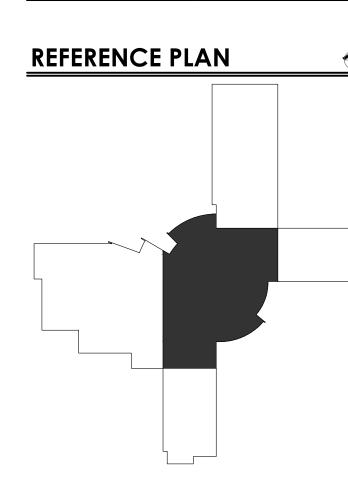

8/14/21

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DRAWING TITLE

DRAWING NUMBER

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BUILDING A

(SFB 1004)

ROOF PLAN

NO. DATE COMMENT


12/27/22 ADDENDUM 01

DATE:

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SG





- REMOVE EXISTING ROOFING SYSTEM TO DECK. CLEAN AND PREP DECK AS REQUIRED FOR NEW ROOF SEE SPECIFICATIONS
- 2. INSTALL NEW ROOFING ON COVER BOARD OVER RIGID INSULATION. TYPICAL SEE SPECIFICATIONS.
- REMOVE AND REPLACE ALL METAL FLASHINGS, REGLETS, AND COUNTER FLASHINGS TYPICAL SEE
- SPECIFICATIONS.
- 4. PROVIDE NEW FLASHING AT MECHANICAL CURBS. ENSURE CONDENSATE LINES ARE PROPERLY SUPPORTED. REMOVE AND REPLACE DUCT SEALANTS. SEE SPECIFICATIONS TYPICAL
- 5. REMOVE EXISTING SLEEPERS UNDER CONDUIT AND PIPE. PROTECT DURING CONSTRUCTION ACTIVITIES. PROVIDE NEW DURA-BLOK SUPPORTS TYPICAL
- 6. CLEAN EXISTING PARAPET WALLS ON ROOF SIDE. WRAP WALLS 4'-0" HIGH AND UNDER WITH KEE MEMBRANE THAT EXTENDS UP AND OVER NEW TREATED WOOD SLEEPERS. PROVIDE BLOCK FILL AND COAT PARAPET WALLS TALLER THAN 4'-0" TO BOTTOM OF COPING - SEE SPECIFICATIONS
- 7. REMOVE ALL CONSTRUCTION JOINT CAULKING FROM ROOF SIDE OF PARAPET AND REPLACE PER SPECIFICATIONS
- 8. PROVIDE NEW SUMPS AS REQUIRED AT EXISTING SCUPPER LOCATIONS. CLEAR ALL DRAIN LEADERS AND ENSURE PROPER OPERATION SEE SPECIFICATIONS - TYPICAL
- 9. RAISE DUCT AS REQUIRED FOR PROPER FLASHING -
- 10. PROVIDE NEW TREATED WOOD NAILERS AND METAL COPING CAPS PER SPECIFICATIONS
- 11. PROVIDE NEW SHEET METAL SCUPPERS
- 12. CLEAR SCUPPERS OF DEBRIS AND ENSURE PROPER OPERATION.
- 13. PROVIDE REPAIRS TO LAPS, SEAMS, RIVETS, PENETRATIONS AND OTHERS AS REQUIRED ON METAL ROOFS. VERIFY IN FIELD. SEE SPECIFICATIONS
- 14. PROVIDE REPAIRS AS REQUIRED VERIFY IN FIELD
- 15. CLEAN ROOF AND PROVIDE NEW COATING SEE
- 16. CLEAR ROOF DRAINS AND ENSURE PROPER
- 17. PROVIDE NEW CONCRETE SPLASH BLOCKS WHERE
- 18. NEW CRICKETS SIZE TO ENSURE PROPER
- DRAINAGE
- 19. PROVIDE NEW ROOF HATCH PROVIDE SUBMITTAL
 - 20. PROVIDE NEW STEEL ROOF ACCESS LADDER PROVIDE SHOP DRAWING TO ARCHITECT SEE DETAIL 1/A1.5
 - 21. REMOVE ALL MECH EQUIPMENT. PROVIDE NEW ROOFING AND FLASHING. REINSTALL ALL EQUIPMENT ON NEW CURB. PROVIDE MECHANICAL, PLUMBING AND MECHANICAL WORK AS REQUIRED TO REMOVE AND REINSTALL SYSTEM. VERIFY PROPER OPERATION AND STARTS UP.

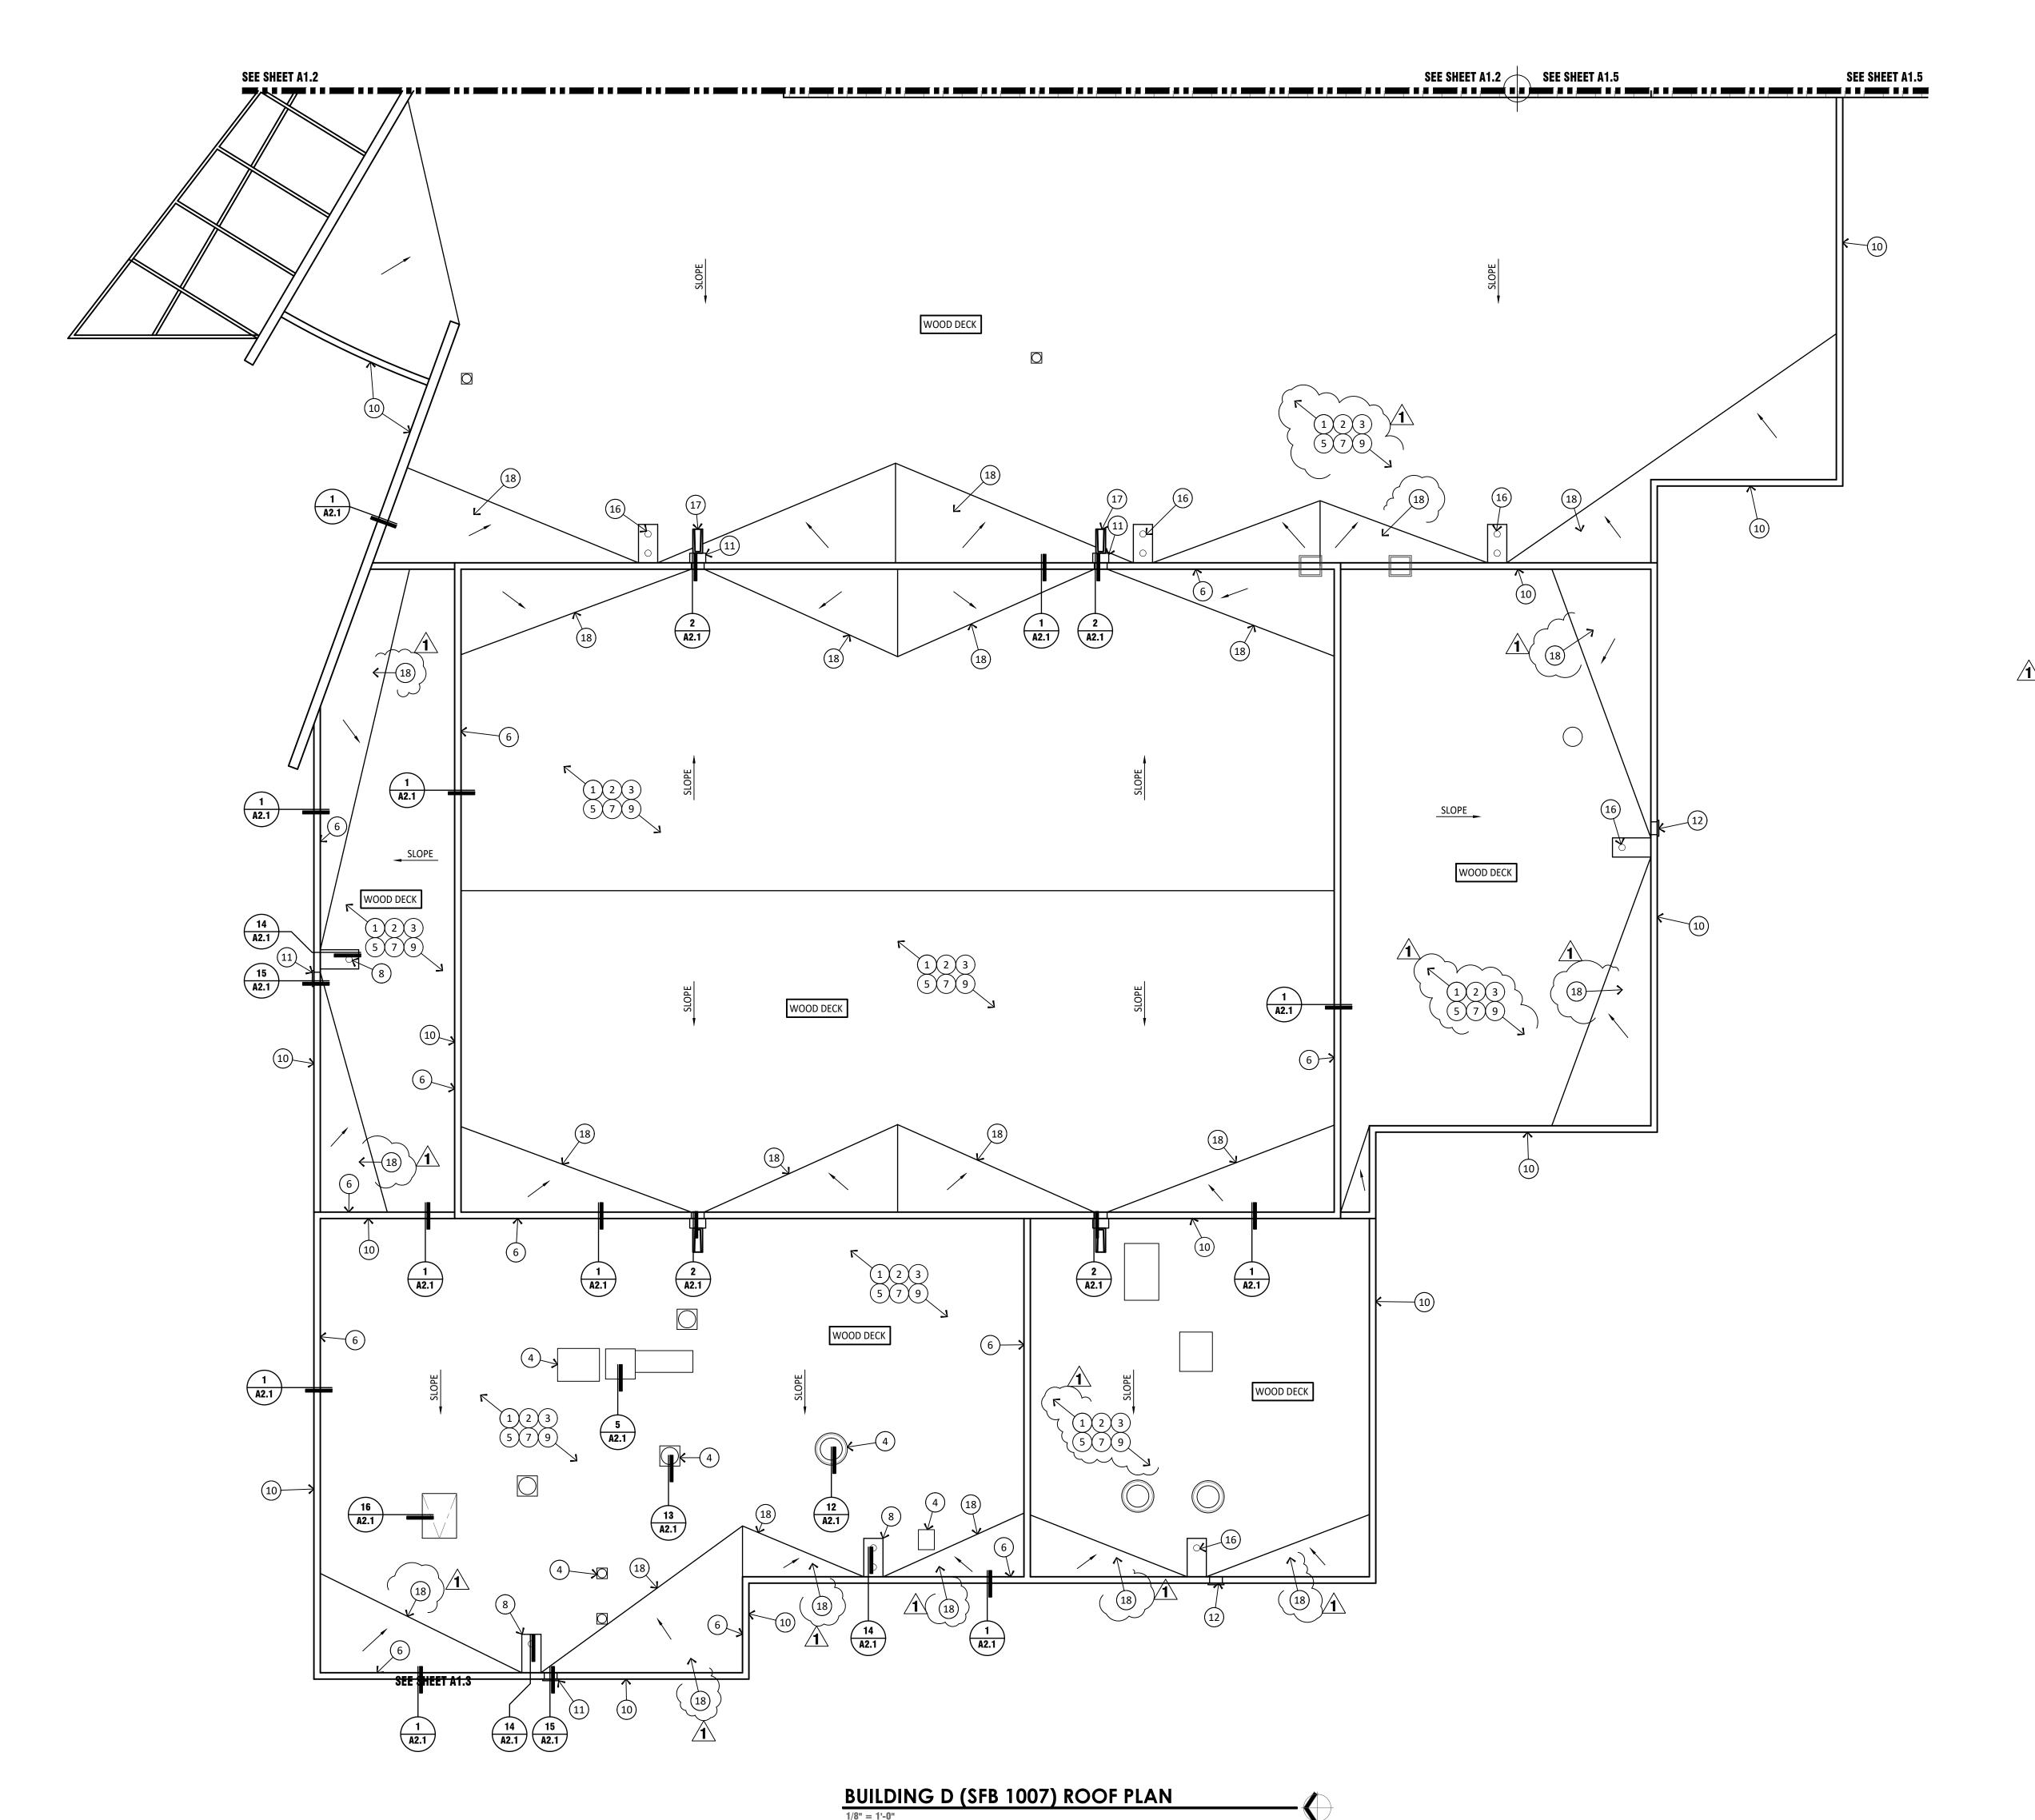GENERAL NOTES

- A. CONTRACTOR TO REVIEW SPECIFICATIONS PRIOR TO BID. NOTIFY ARCHITECT OF ANY CONFLICTS.
- B. KEYNOTES ARE TYPICAL THROUGHOUT
- C. ANY INCIDENTAL MECHANICAL, PLUMBING OR ELECTRICAL ASSOCIATED WITH ROOFTOP EQUIPMENT SHALL BE PERFORMED BY PROPER LICENSED SUBCONTRACTORS UNDER THIS ROOFING CONTRACT - ALL WORK SHALL BE PERFORMED TO CURRENT CODES
- D. ADJUST EXISTING ELECTRICAL CONDUIT. CONDENSATE AND UTILITY LINES AS REQUIRED FOR NEW ROOF HEIGHT. PROVIDE NEW DURA BLOK SUPPORTS - TYPICAL - SEE SPECIFICATIONS.
- E. REMOVE EXISTING LOW VOLTAGE WIRE AND REINSTALL AFTER ROOF REPLACEMENT
- REMOVE AND PATCH ALL ABANDONED OPENINGS. NOTIFY ARCHITECT IF OPENING IS WIDER THAN 12' X 12"
- G. REMOVE AND REPLACE EXISTING LIGHTNING PROTECTION SYSTEM. NEW SYSTEM TO BE RE CERTIFIED
- H. DEMO ALL ABANDONED PITCH PANS. CAP WATER AND POWER

TYPICAL DETAILS THROUGHOUT

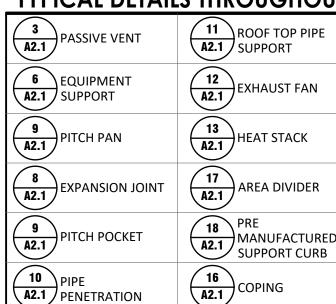

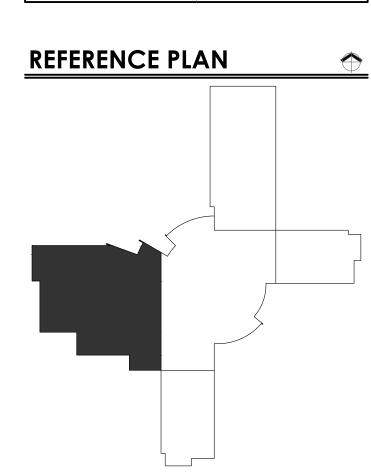

PROJECT NO.: 21170 DRAWN BY: B. TUTTLE CHECKED BY: L. LIND

Architechnology ARCHITECTURE - FACILITIES - C.M. 5229 N. 7th AVE. #101 PHOENIX, ARIZONA 85013 602.347.5226) ELEMMENTARY SCHOOL DISTRICT

8/14/21

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BUILDING D

(SFB 1007)

ROOF PLAN

NO. DATE COMMENT


12/27/22 ADDENDUM 01

DATE:

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- 4. PROVIDE NEW FLASHING AT MECHANICAL CURBS. ENSURE CONDENSATE LINES ARE PROPERLY SUPPORTED. REMOVE AND REPLACE DUCT SEALANTS. SEE SPECIFICATIONS TYPICAL
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- 11. PROVIDE NEW SHEET METAL SCUPPERS
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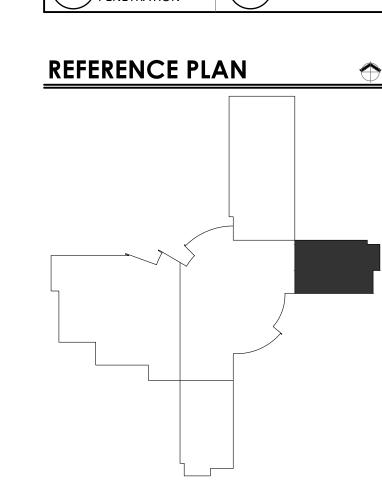
 - 20. PROVIDE NEW STEEL ROOF ACCESS LADDER PROVIDE SHOP DRAWING TO ARCHITECT SEE
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- G. REMOVE AND REPLACE EXISTING LIGHTNING PROTECTION SYSTEM. NEW SYSTEM TO BE RE CERTIFIED

H. DEMO ALL ABANDONED PITCH PANS. CAP WATER AND POWER TYPICAL DETAILS THROUGHOUT

TIPICAL DETAIL	<u>.3 INKOUGHOU</u>
A2.1 PASSIVE VENT	ROOF TOP PIPE SUPPORT
6 EQUIPMENT SUPPORT	A2.1 EXHAUST FAN
9 A2.1 PITCH PAN	A2.1 HEAT STACK
8 A2.1 EXPANSION JOINT	A2.1 AREA DIVIDER
9 PITCH POCKET	PRE MANUFACTURES SUPPORT CURB
PIPE PENETRATION	(A2.1) COPING

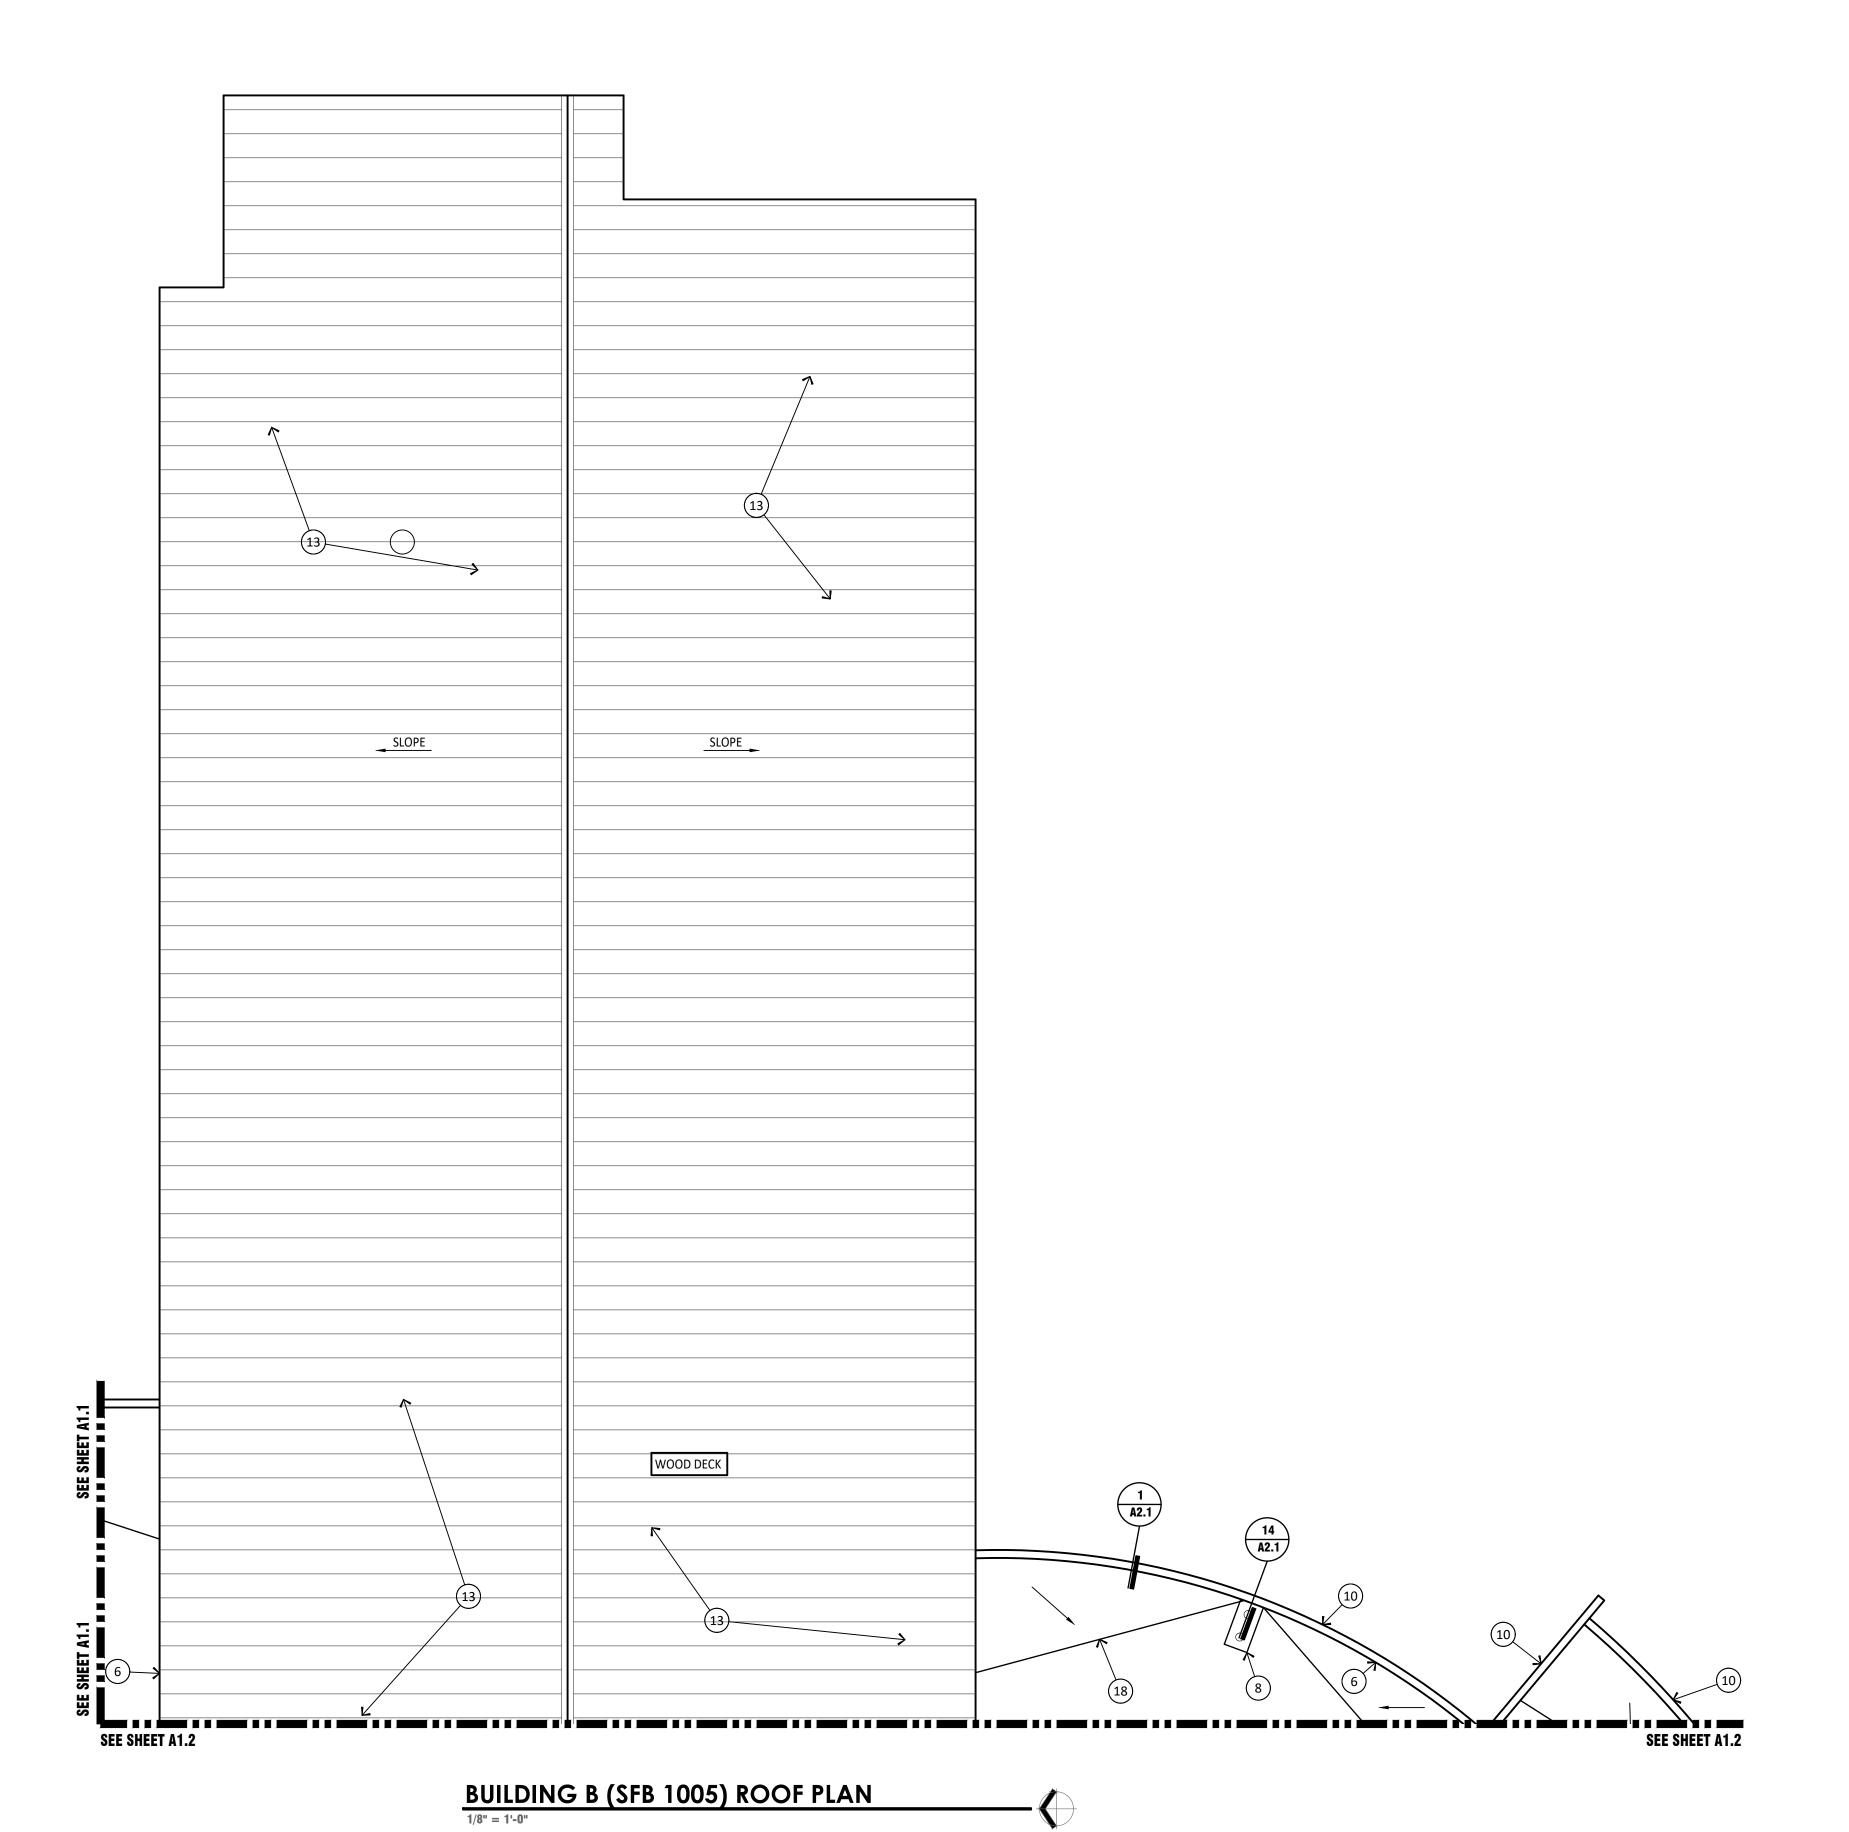

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PROJECT NO.: 21170 DRAWN BY: B. TUTTLE CHECKED BY: L. LIND

NO. DATE COMMENT

12/27/22 ADDENDUM 01

8/14/21

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BUILDING B

(SFB 1005)

ROOF PLAN

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DRAWING TITLE

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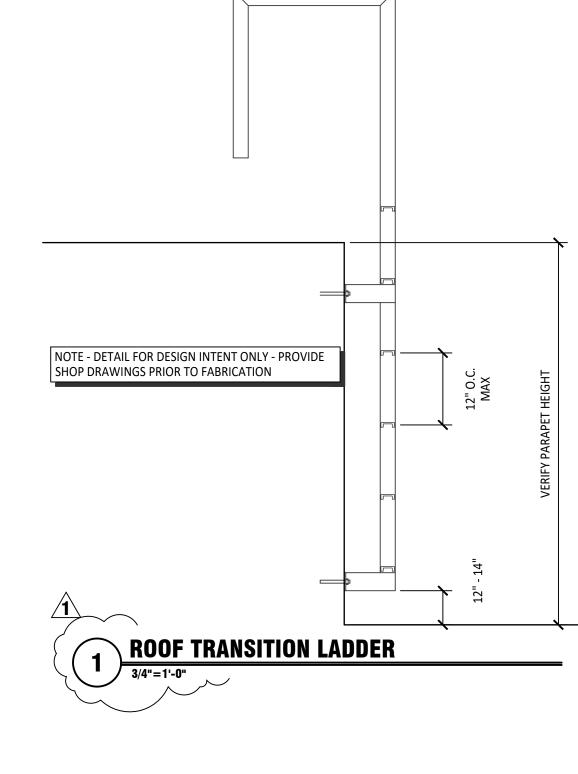
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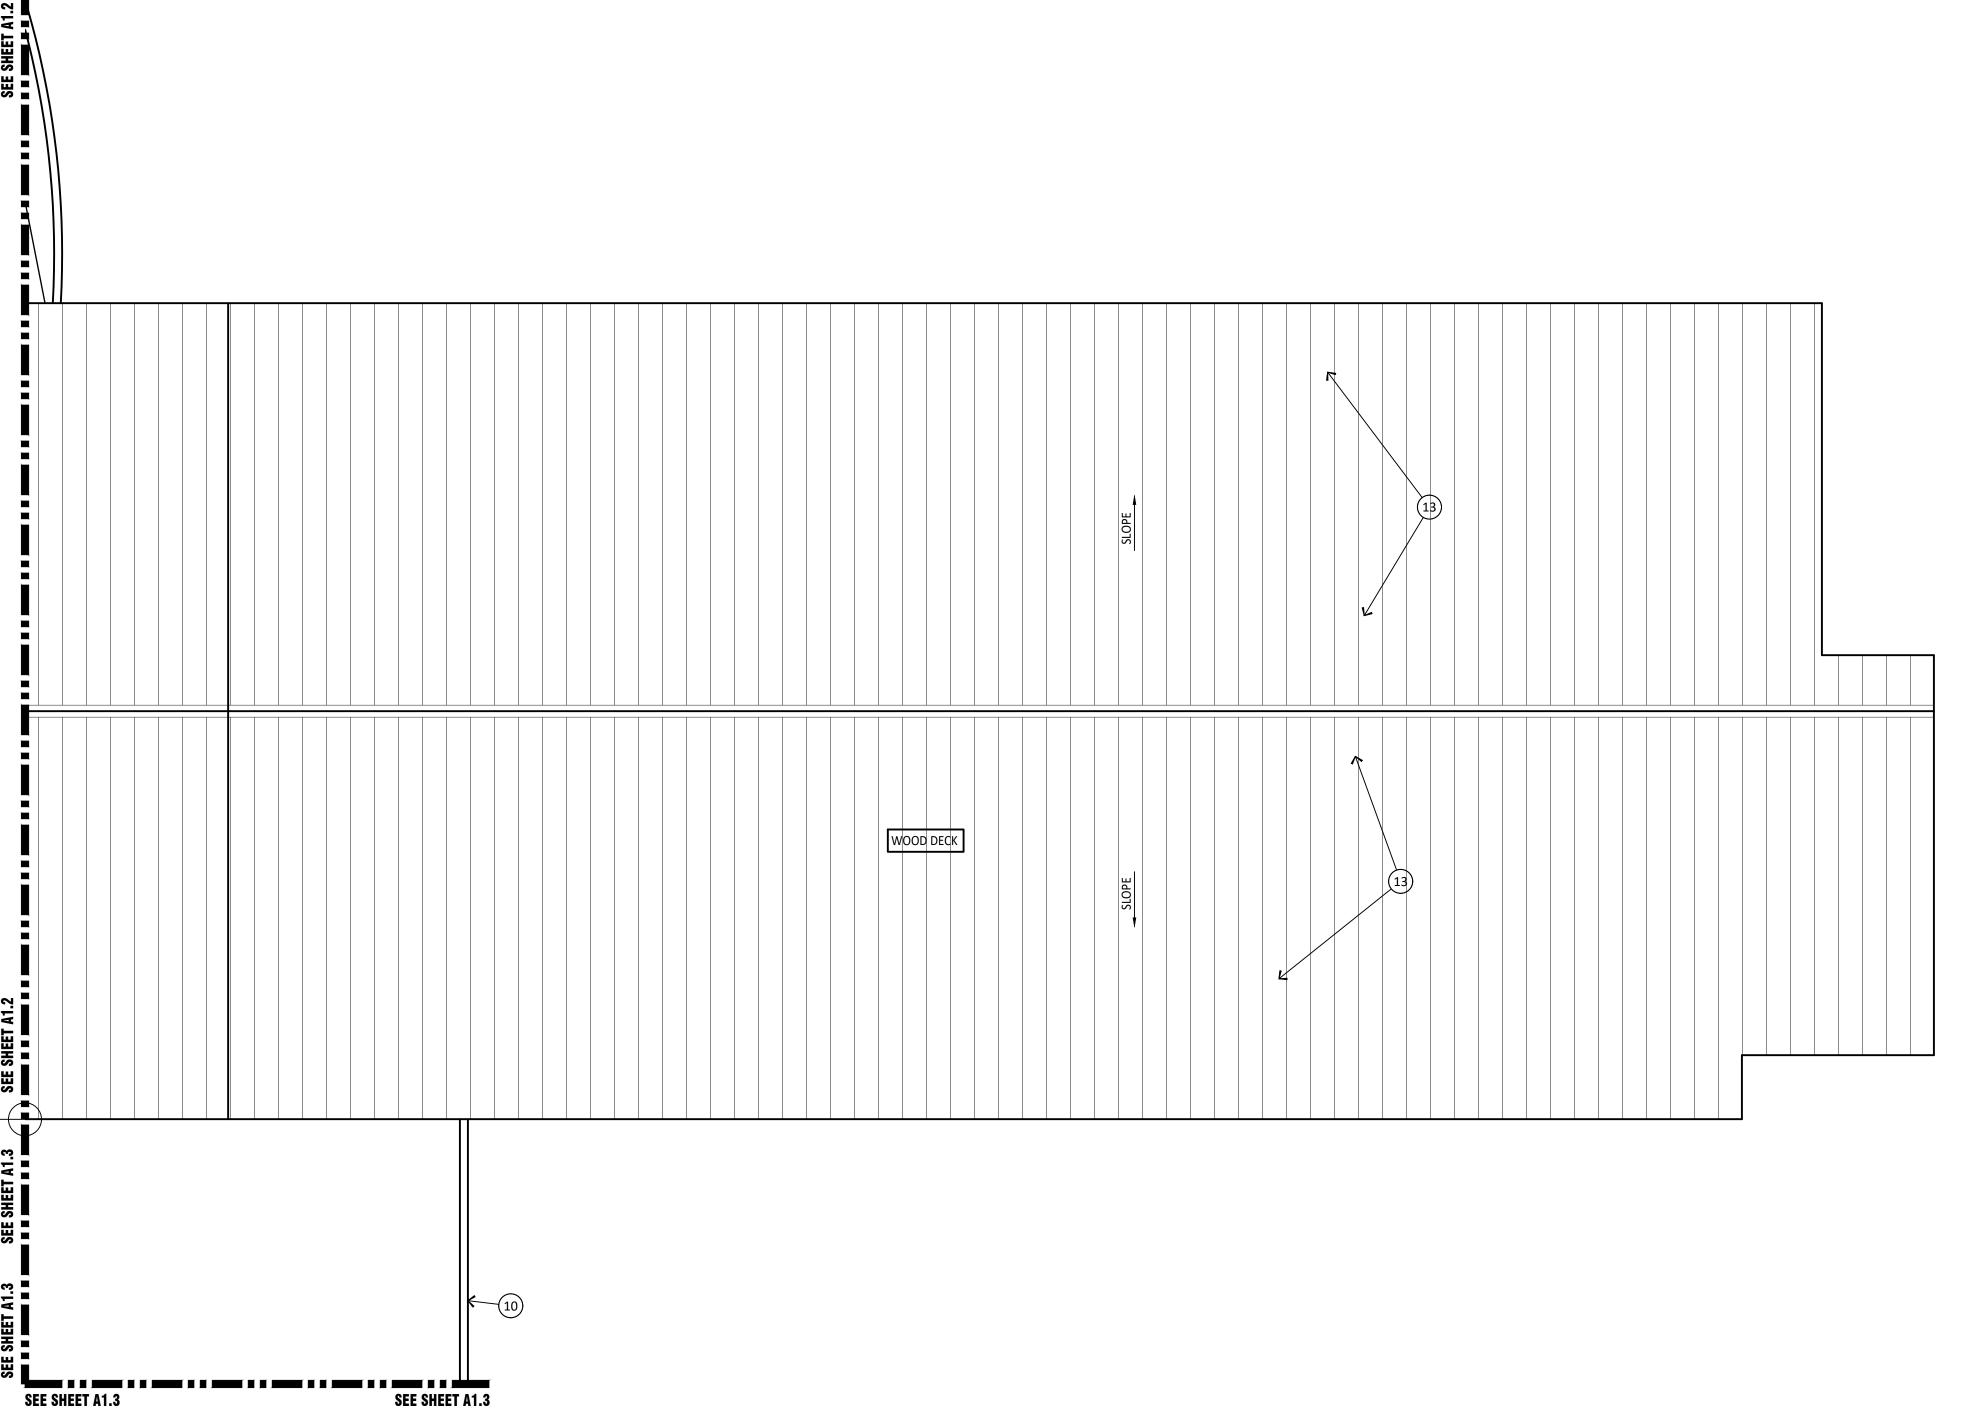
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Washington **Elementary**

SCHOOL DISTRICT







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– αш PROJECT NO.: 21170 DRAWN BY: B. TUTTLE CHECKED BY: L. LIND DATE: 8/14/21 NO. DATE COMMENT 12/27/22 ADDENDUM 01

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Architechnology

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SCHOOL DISTRICT

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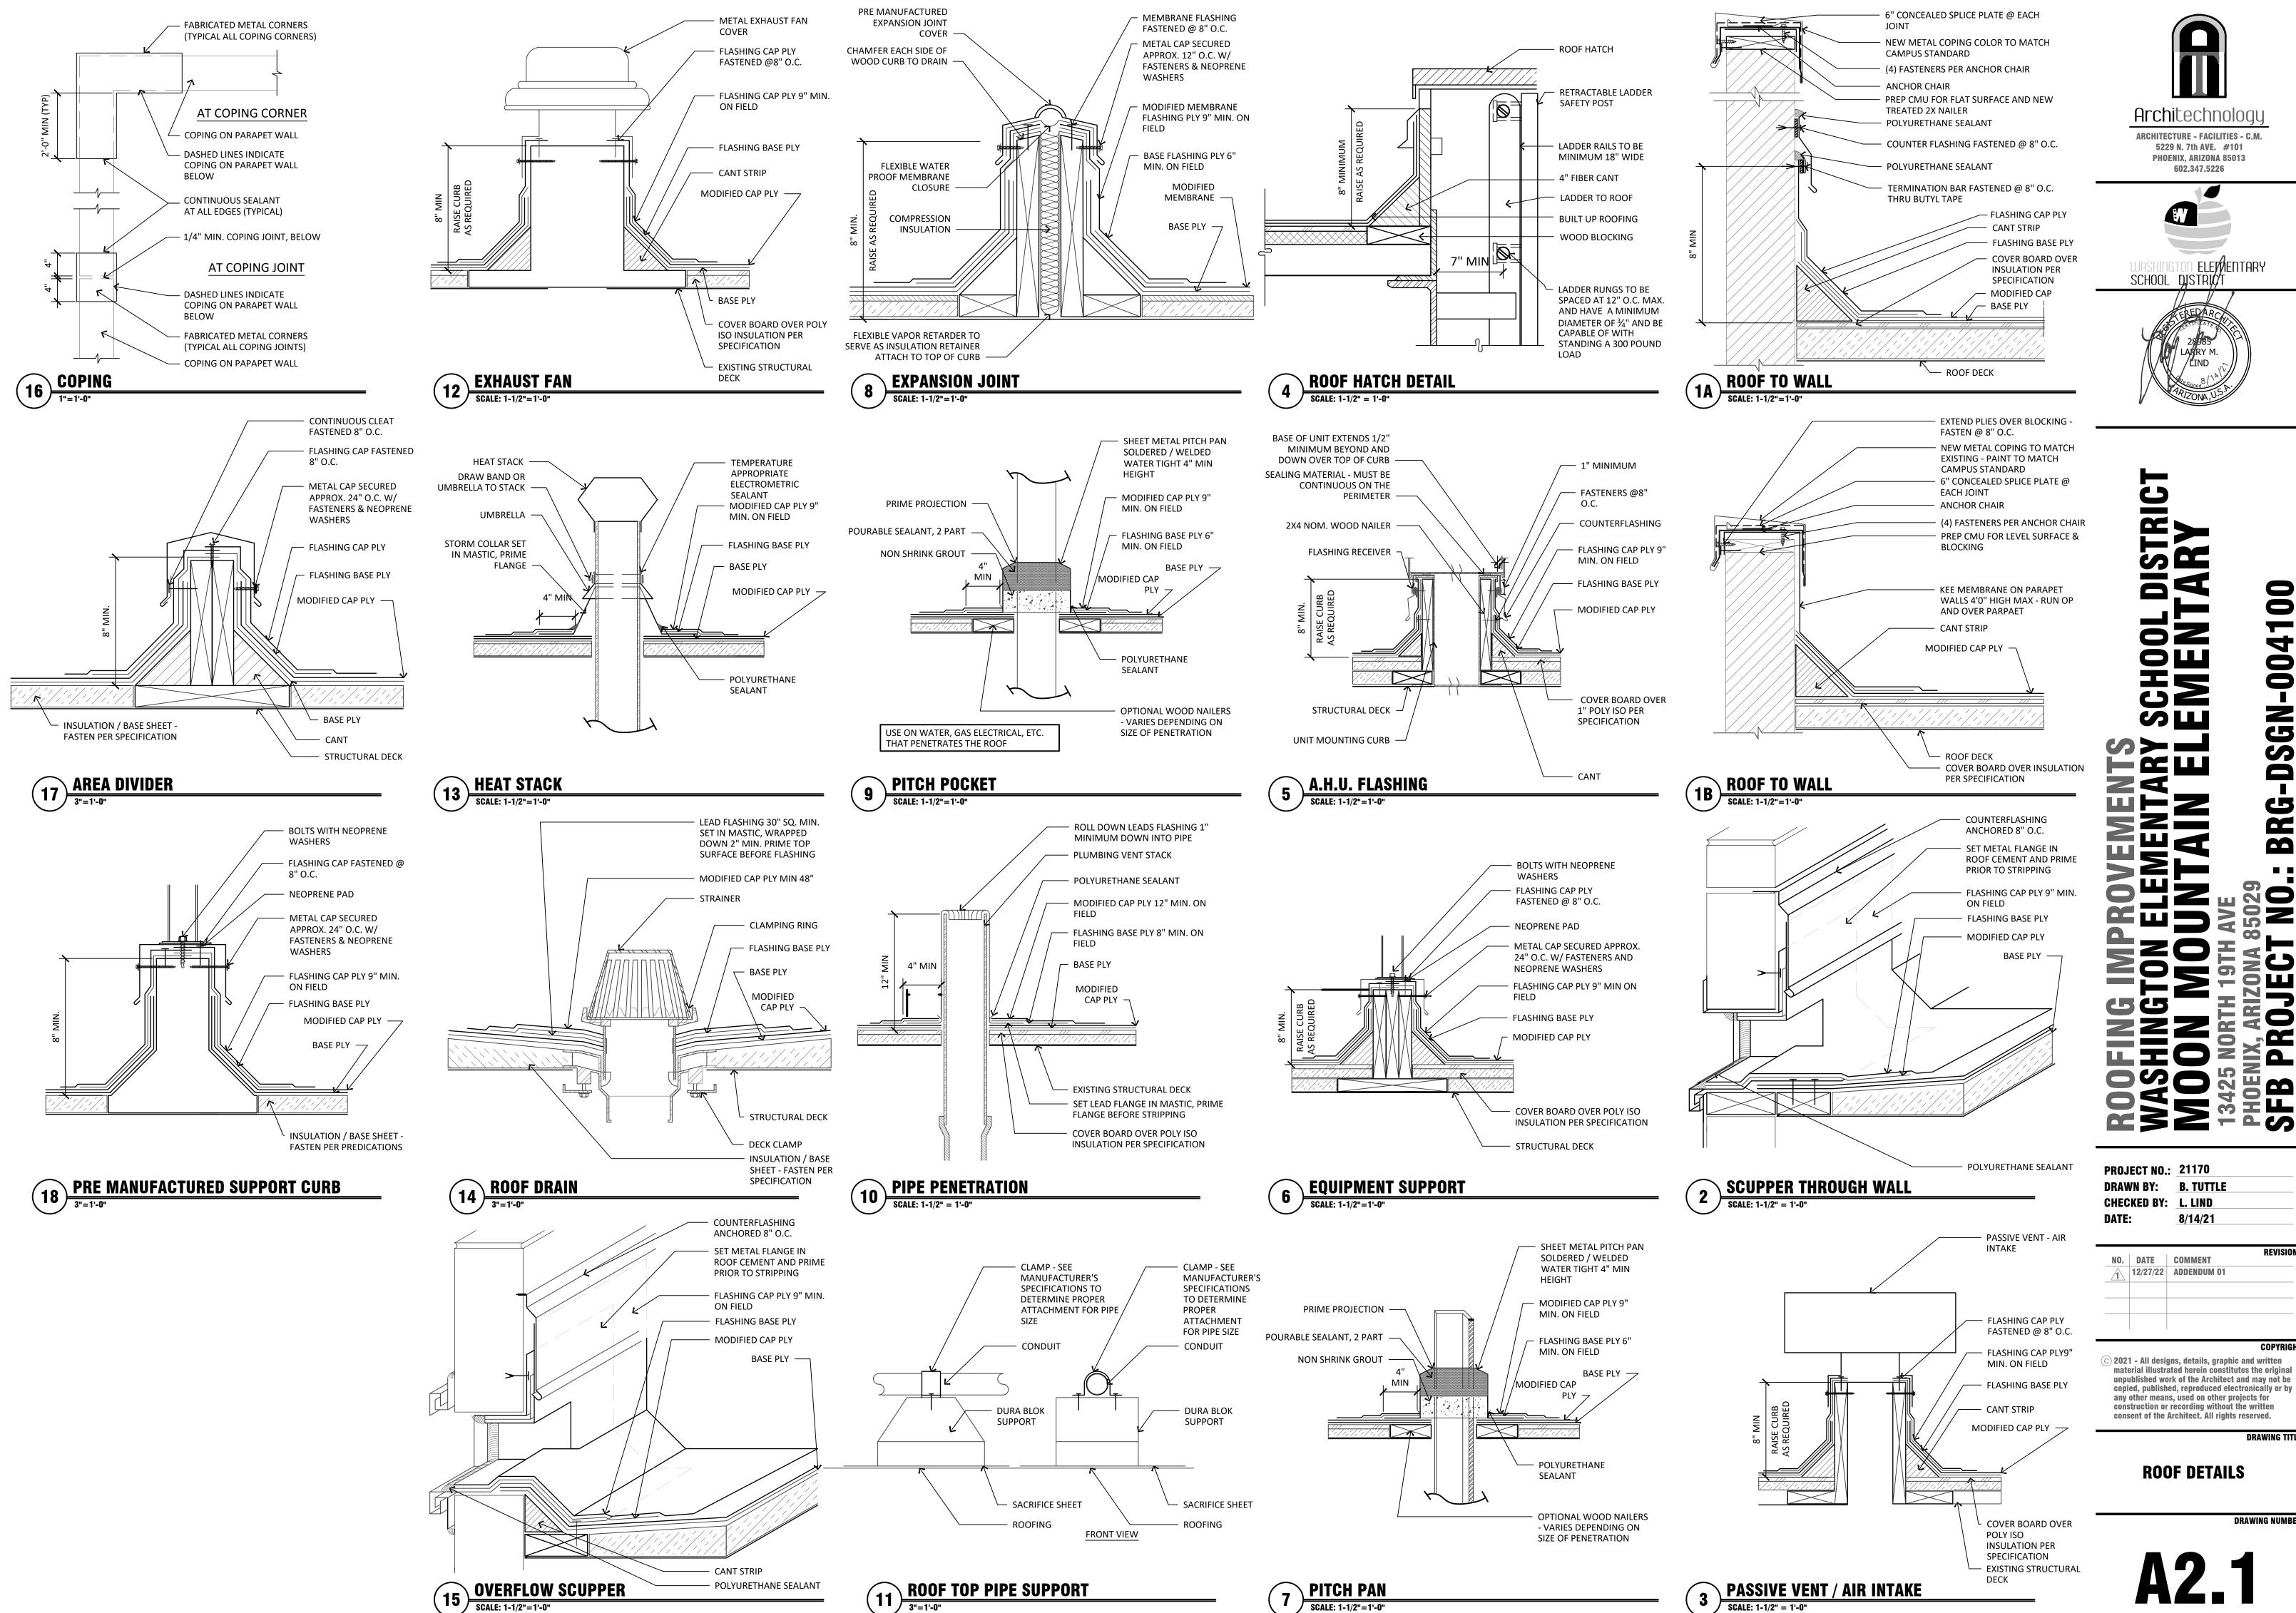
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DRAWING TITLE **BUILDING C** (SFB 1006) **ROOF PLAN**

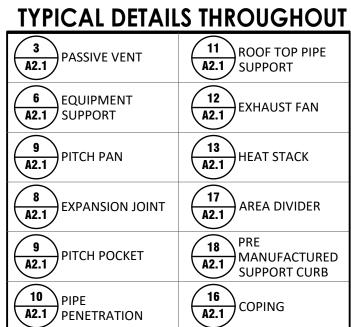

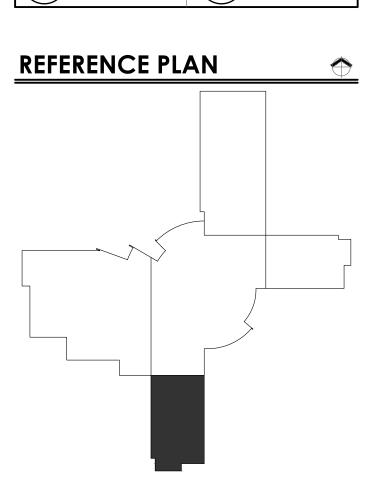DRAWING NUMBER

-004100

SGN

70

ADDENDUM: Number 01

DATE: December 27, 2022

TO: Interested Bidders

CLIENT: Washington Elementary School District

Phoenix, Arizona

PROJECT: Ocotillo Elementary School Roofing Improvements

SITE: Ocotillo Elementary School

Phoenix, Arizona

ARCHITECT: Architechnology, Inc.

5229 North 7th Avenue, Suite 101

Phoenix, Arizona 85013

AT PROJECT NO: 21-165

1. INSTRUCTIONS


1. This supplement to Bid Documents is issued prior to the receipt of bids. All Work covered in the supplement shall be included in the original quotation and the Supplement will be considered an integral part of the Contract Documents.

Architechnology

2. All work performed under this Supplement shall be subject to the General Conditions of the Contract and the Specifications for similar work in connection with this Project.



- A. General Items No changes.
- B. Addendum Drawings. Change.
 - a. Delete Bid Drawings, dated 10.12.2021 and replace with Addendum No. 01 Drawings, dated 12.27.2022.
- C. Addendum Specifications. No changes.

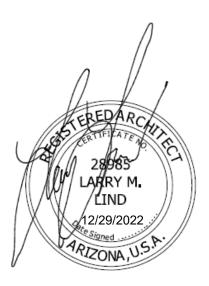


WASHINGTON ELEMENTARY SCHOOL DISTRICT



ROOFING IMPROVEMENTS OCOTILLO ELEMENTARY SFB PROJECT NO.: BRG-DSGN-00431

3225 WEST OCCTILLO ROAD PHOENIX, ARIZONA 85017

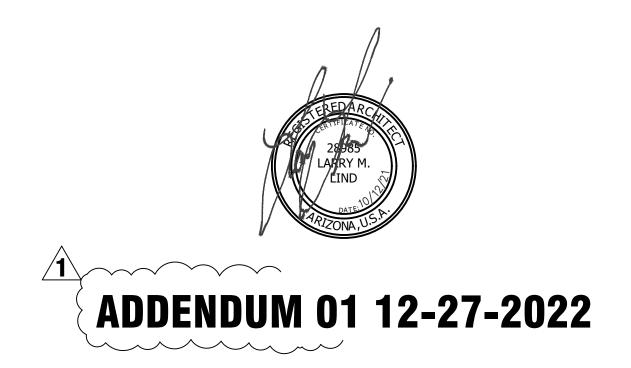



FAX: 602.234.1561



LAB. LABORATOR\ BUILDING LAM. LAMINATE BLOCK BLK'G **LAVATORY** BLOCKING LAV. BEAM LIGHT

BLK.

BM.

BOT.

F.O.B.

F.O.C.

F.S.

FTG.

GA.

G.C.

HT.

FURR.

FT.

FACE OF BRICK

FULL SIZE

FACE OF CONCRETE

BOTTOM MAX. **MAXIMUM BETWEEN** MECH. **MECHANICAL** BUILT UP ROOFING

BTWN. B.U.R. B.W. **BOTH WAYS** MEMB. MEMBRANE MFR. **MANUFACTURER CONTROL JOINT** M.H. C.J. MANHOLE CLG. MINIMUM CEILING MIN. CLKG. CAULKING **MISCELLANEOUS** CLR. M.O. CLEAR MASONRY OPENING CONCRETE MASONRY UNIT CMU MTL. METAL

COL. COLUMN MUL. MULLION CONC. CONCRETE **NORTH** CONSTR CONSTRUCTION CONT. NOT IN CONTRACT CONTINUOUS N.I.C. C.T. CARPET TILE NO. NUMBER **NOMINAL**

DEG. DEGREE NOT TO SCALE DET. / DETL. DETAIL O.C. ON CENTER DRINKING FOUNTAIN O.D. DIAG. DIAGONAL OUTSIDE DIAMETER DIA. DIAMETER OH. OVERHEAD OPG. DN. OPENING DOWN OPP. OPPOSITE DS. DOWNSPOU DWG. DRAWING PRE-CAST

PCT. PROPERTY LINE PLAM. PLASTIC LAMINATE **EXISTING PLASTER** EACH PLYWD. PLYWOOD **EXPANSION JOINT EXTERIOR INSULATION & FINISH SYSTEM** E.I.F.S.

EL. / ELEV. **ELEVATION** RISER ELEC. ELECTRICAL R.D. **ROOF DRAIN** EMER. **EMERGENCY** REFER TO ENCL. **ENCLOSURE** REFR. REFRIGERATOR EQ. REQ'D REQUIRED EQUIP. **EQUIPMENT** RM ROOM E.W. **EACH WAY ROUGH OPENING ELECTRIC WATER COOLER** E.W.C. EXP. **EXPANSION** SOUTH EXT. EXTERIOR

F.A. FIRE ALARM SECTION F.D. FLOOR DRAIN **SQUARE FOOT** F.D.C. FIRE DEPARTMENT CONNECTION SHT. SHEET F.E. FIRE EXTINGUISHER **SIMILAR** F.E.C. FIRE EXTINGUISHER CABINET SPEC. **SPECIFICATION** F.F. FINISH FLOOR SQ. SQUARE F.H.C. FIRE HOSE CABINET S.S. STAINLESS STEEL FIN. FINISH STAGG. STAGGERED F.L. FLOW LINE STD. **STANDARD** FLR. FLOOR STIFF. STIFFENER FLOUOR. **FLUORESCENT** STL. STEEL FND. **FOUNDATION**

SOLID CORE

STRUCTURAL

SUSPENDED

SCHEDULE

SCHED.

STRUC.


SUSP.

TR. READ FOOT OR FEET T & B TOP AND BOTTOM **FOOTING** TERRAZZO TFR. **FURRING** T & G **TONGUE AND GROOVE** THICK GAUGE TOP OF GALVANIZED GENERAL CONTRACTOR TYP. TYPICAL GLASS

VINYL COMPOSITION TILE GRADE GR. GYP. GYPSUM VER. GYP. BD. **GYPSUM BOARD** VERT. VERTICAL WEST H.B. HOSE BIB W/ WITH H.C. **HOLLOW CORE**

W.C. WATER CLOSET H/C HANDICAPPED WD. WOOD HDWD. HARDWOOD **HDWE** HARDWARE W/O WITHOUT H.M. **HOLLOW METAL** HR.

HOUR HEIGHT reference site plan NTS 🕀

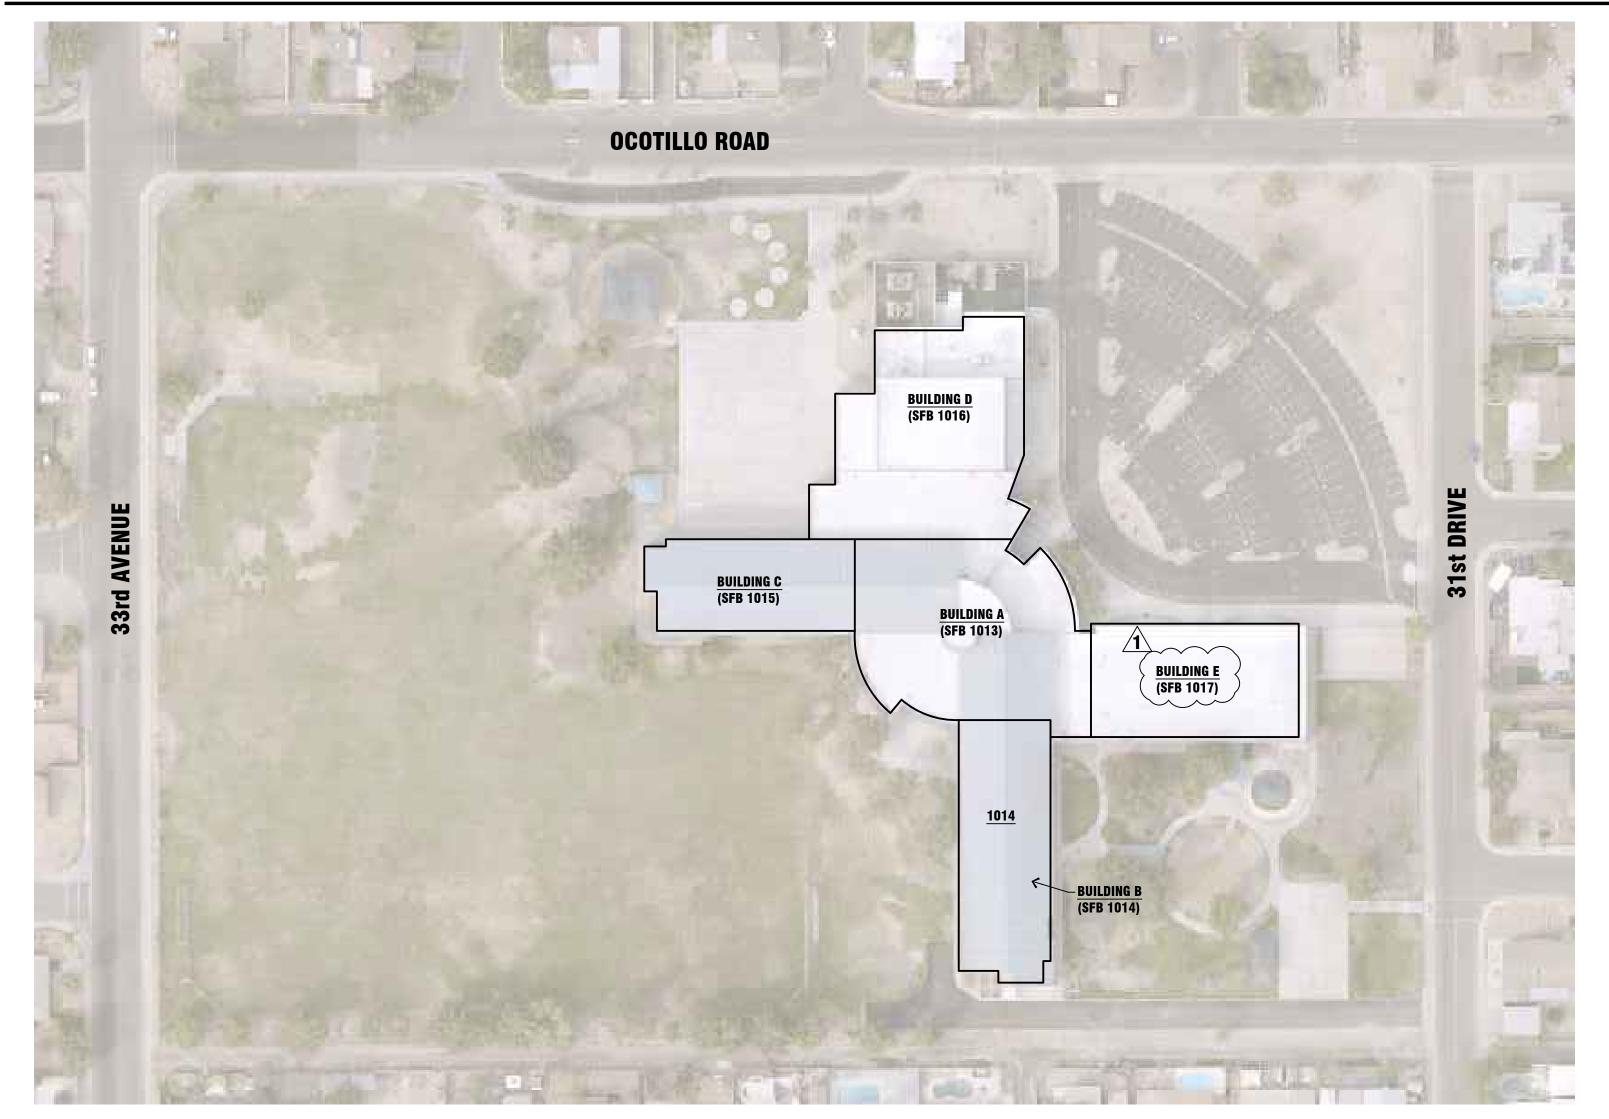

general notes

- A. THE CONTRACTOR SHALL COMPLY WITH ALL APPLICABLE CODES, LAWS, AND ORDINANCES HAVING JURISDICTION ON THIS PROJECT.
- B. ALL OMISSIONS AND CONFLICTS BETWEEN THE VARIOUS ELEMENTS OF THE CONTRACT DOCUMENTS SHALL BE BROUGHT TO THE ATTENTION OF THE ARCHITECT AND RESOLVED PRIOR TO PROCEEDING WITH ANY CONSTRUCTION
- C. THE CONTRACTOR SHALL VERIFY ALL EXISTING DIMENSIONS, CLEARANCES, AND CONDITIONS. ANY DISCREPANCIES OR CONFLICTS SHALL BE REPORTED TO THE ARCHITECT PRIOR TO COMMENCEMENT OF WORK.
- D. WE CERTIFY TO THE BEST OF OUR KNOWLEDGE, INFORMATION AND BELIEF, THAT THE DESIGN OF THIS PROJECT COMPLIES WITH THE APPLICABLE PROVISIONS & REQUIREMENTS OF SECTION 34-4-1 TO 34-411 INCLUSIVE OF THE STATUTES OF THE STATE OF ARIZONA.
- E. AS PER THE SPECIFICATION SECTION FOR PROJECT CLOSE-OUT, THE ARCHITECT WILL ISSUE A "CERTIFICATE OF SUBSTANTIAL COMPLETION OF THE PROJECT
- F. ANY FUTURE CHANGE OR REVISIONS TO THESE PLANS SHALL BE SUBMITTED TO THE CITY FOR REVIEW, AND APPROVAL PRIOR TO COMMENCING ANY WORK.
- G. ALL CHANGES AND/OR REVISIONS SHALL BE NOTED ON THE PLANS BY "CLOUDING" THE AREAS AFFECTED BY THESE REVISIONS OR CHANGES, AND WITH "DELTAS" INDICATING THE NUMBER OF TIMES THE CHANGES OCCUR. IN ADDITION, THE DATE OF THESE CHANGES OR REVISIONS SHALL BE INDICATED. THIS DATA SHALL ALSO BE PLACED IN THE TITLE BLOCK, IN AN APPROPRIATE BULLETIN OR SCHEDULE.
- H. SEE SPECIFICATIONS FOR PRIOR APPROVALS. IF NO PRIOR APPROVAL IS SUBMITTED THEN BID MUST BE TO ROOF MANUFACTURE SPECIFIED AS "BASIS OF DESIGN"

roofing general notes

- A. ALL NEW ROOF PENETRATIONS TO BE FULLY WATER TIGHT. REPAIR EXISTING METAL FLASHING/FASCIA AS REQUIRED. REFER TO DETAILS.
- B. ROOF AREA NUMBERS ARE SHOWN FOR ROOF AREA LOCATION COMMUNICATION
- C. ALL MECHANICAL UNITS, EXHAUST FANS, MECHANICAL EQUIPMENT, ETC. MOUNTED ON ROOF SHALL BE PROVIDED WITH CRICKETING AS REQUIRED TO PROVIDE POSITIVE ROOF DRAINAGE, TYPICAL.
- D. VERIFY ALL ROOF DECK CONDITIONS PRIOR TO ANY ROOFING ACTIVITIES.
- E. COORDINATE ALL MECHANICAL ROOF MOUNTED EQUIPMENT FOR PROPER CURB REQUIREMENTS AND PENETRATION OPENINGS SO THAT PROPER FLASHING MAY BE INSTALLED AS TO CONFORM WITH THE MANUFACTURER'S STANDARD DETAILS / INSTALLATION REQUIREMENTS.
- NOT ALL PENETRATIONS MAY BE INDICATED. CONTRACTOR TO FIELD VERIFY. FOR TYPICAL VENT AND PIPE PENETRATIONS THROUGH ROOF MEMBRANE,
- G. REFER TO PLANS FOR LOCATIONS OF NEW COPING, GUTTERS, AND ASSOCIATED DETAILS.
- H. ALL SHEET METAL FABRICATIONS TO COMPLY WITH THE LATEST SMACNA

ARCHITECTURAL SHEET METAL MANUAL - TYPICAL.

REMOVE ALL EXISTING PARAPET WALL REGLETS (U.N.O.) EXISTING PARAPET WALL COUNTER FLASHING AT REGLET TO BE REMOVED FOR INSTALLATION OF NEW ROOF MEMBRANE. INSTALL NEW COUNTER FLASHING AS REQUIRED TO CONFORM WITH /1_A1.3_BUILDING D (SEB 1016) ROOF PLAN MANUFACTURES ROOF WARRANTY. PAINT ALL REGLETS AND COUNTER FLASHING

I. MECHANICAL UNITS, EQUIPMENT, VENTS, ETC. SHOWN ARE DIAGRAMMATIC. THEY ARE NOT TO SCALE AND THE LOCATIONS ARE APPROXIMATE. NOT ALL ROOFING PENETRATIONS HAVE BEEN SHOWN. CONTRACTOR TO FIELD VERIFY QUANTITIES, SIZES, AND LOCATIONS OF MECHANICAL AND ELECTRICAL PENETRATIONS PRIOR TO BIDDING. NO ADDITIONAL COMPENSATION WILL BE ALLOWED FOR ADDITIONAL

COLOR TO MATCH ADJACENT PARAPET WALLS.

ROOFING PENETRATIONS NOT INDICATED ON DRAWINGS.

- CONTRACTOR IS RESPONSIBLE TO VISIT SITE TO ASCERTAIN THE FULL EXTENT OF THE WORK REQUIRED. NO ADDITIONAL COMPENSATION WILL BE ALLOWED FOR FAILURE TO ASCERTAIN FULL EXTENT OF THE WORK REQUIRED THROUGH VISUAL INSPECTION OF EXISTING CONDITIONS AND THAT DETAILED AND SPECIFIED WITHIN THE CONTRACT DOCUMENTS.
- ROOF SLOPED INDICATED ARE APPROXIMATE. CONTRACTOR TO VERIFY IF SLOPE IS PROVIDED IN THE STRUCTURE OF BUILDING OR IF TAPERED INSULATION WILL BE REQUIRED TO PROVIDE SLOPE
- M. CONTRACTOR TO PROVIDE WARRANTED WATER TIGHT ROOF CONSTRUCTION AND FLASHING AT ALL NEW ROOFING INSTALLATIONS EXCEPT AT EXISTING ROOFING TO REMAIN. CONTRACTOR TO VISUALLY INSPECT ALL METAL COPING TO REMAIN FOR POTENTIAL SOURCES OF LEAKS AND PROVIDE REPORT TO ARCHITECT FOR REVIEW.
- N. CONTRACTOR IS RESPONSIBLE FOR INSPECTING INTERIOR ROOF LEADERS TO ENSURE THAT THEY ARE NOT LEAKING. IF LEAKS ARE DISCOVERED, THE CONTRACTOR SHALL NOTIFY THE OWNER AND THE ARCHITECT.

project information

PROJECT NAME: **ROOFING IMPROVEMENTS**

OWNER: WASHINGTON ELEMENTARY SCHOOL DISTRICT

4650 WEST SWEETWATER

GLENDALE, AZ 85304 PHONE: 602-347-2600

PROJECT SITE: OCOTILLO ELEMENTARY SCHOOL

3225 WEST CACTUS PHOENIX, AZ 85017

ARCHITECT: ARCHITECHNOLOGY INC. LARRY M. LIND, A.I.A. PRINCIPAL ARCHITECT / ROOF CONSULTANT

5229 N. 7TH AVE. STE 101 PHOENIX, ARIZONA 85013 P (602) 347-5226 F (602) 234-1561

washington elementary school district

GOVERNING BOARD: BOARD PRESIDENT - BILL ADAMS

VICE PRESIDENT - NIKKIE WHALEY

BOARD MEMBER - TEE LAMBERT

BOARD MEMBER - JENNI ABBOTT-BAYARDI

BOARD MEMBER - LINDSEY PETERSON

SUPERINTENDENT: DR. PAUL STANTON

applicable codes

ALL CONSTRUCTION SHALL COMPLY WITH THE FOLLOWING BUILDING CODES AND AMENDMENTS PER THEIR ADOPTING ORDINANCES:

2018 INTERNATIONAL BUILDING CODE 2018 INTERNATIONAL EXISTING BUILDING CODE 2018 INTERNATIONAL RESIDENTIAL CODE 2018 INTERNATIONAL MECHANICAL CODE

2018 INTERNATIONAL FUEL GAS CODE 2018 INTERNATIONAL ENERGY CONSERVATION CODE 2017 NATIONAL ELECTRICAL CODE

2018 UNIFORM PLUMBING CODE 2018 INTERNATIONAL SWIMMING POOL AND SPA CODE

sheet index

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A1.2 BUILDING A (SFB 1013) ROOF PLAN A1.4 BUILDING B (SFB 1014) ROOF PLAN

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Architechnology ARCHITECTURE - FACILITIES - C.M. 5229 N. 7th AVE. #101 PHOENIX, ARIZONA 85013 602.347.5226

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PROJECT NO.: 21165 DRAWN BY: D. LIND CHECKED BY: L. LIND 10/12/21 DATE:

NO. DATE COMMENT 12/27/22 ADDENDUM 01


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GENERAL INFORMATION REFERENCE SITE PLAN

OCOTILLO OVERALL ROOF PLAN





MASHINGTON ELEMENTARY SCHOOL DISTRICT OCOTILLO ELEMENTARY SCHOOL DISTRICT

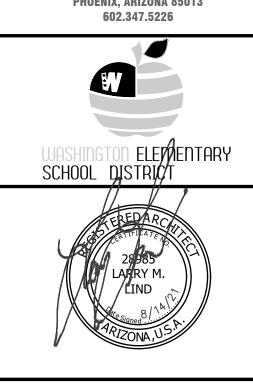PROJECT NO.: 21165

DRAWN BY: D. LIND

CHECKED BY: L. LIND

DATE: 10/12/21

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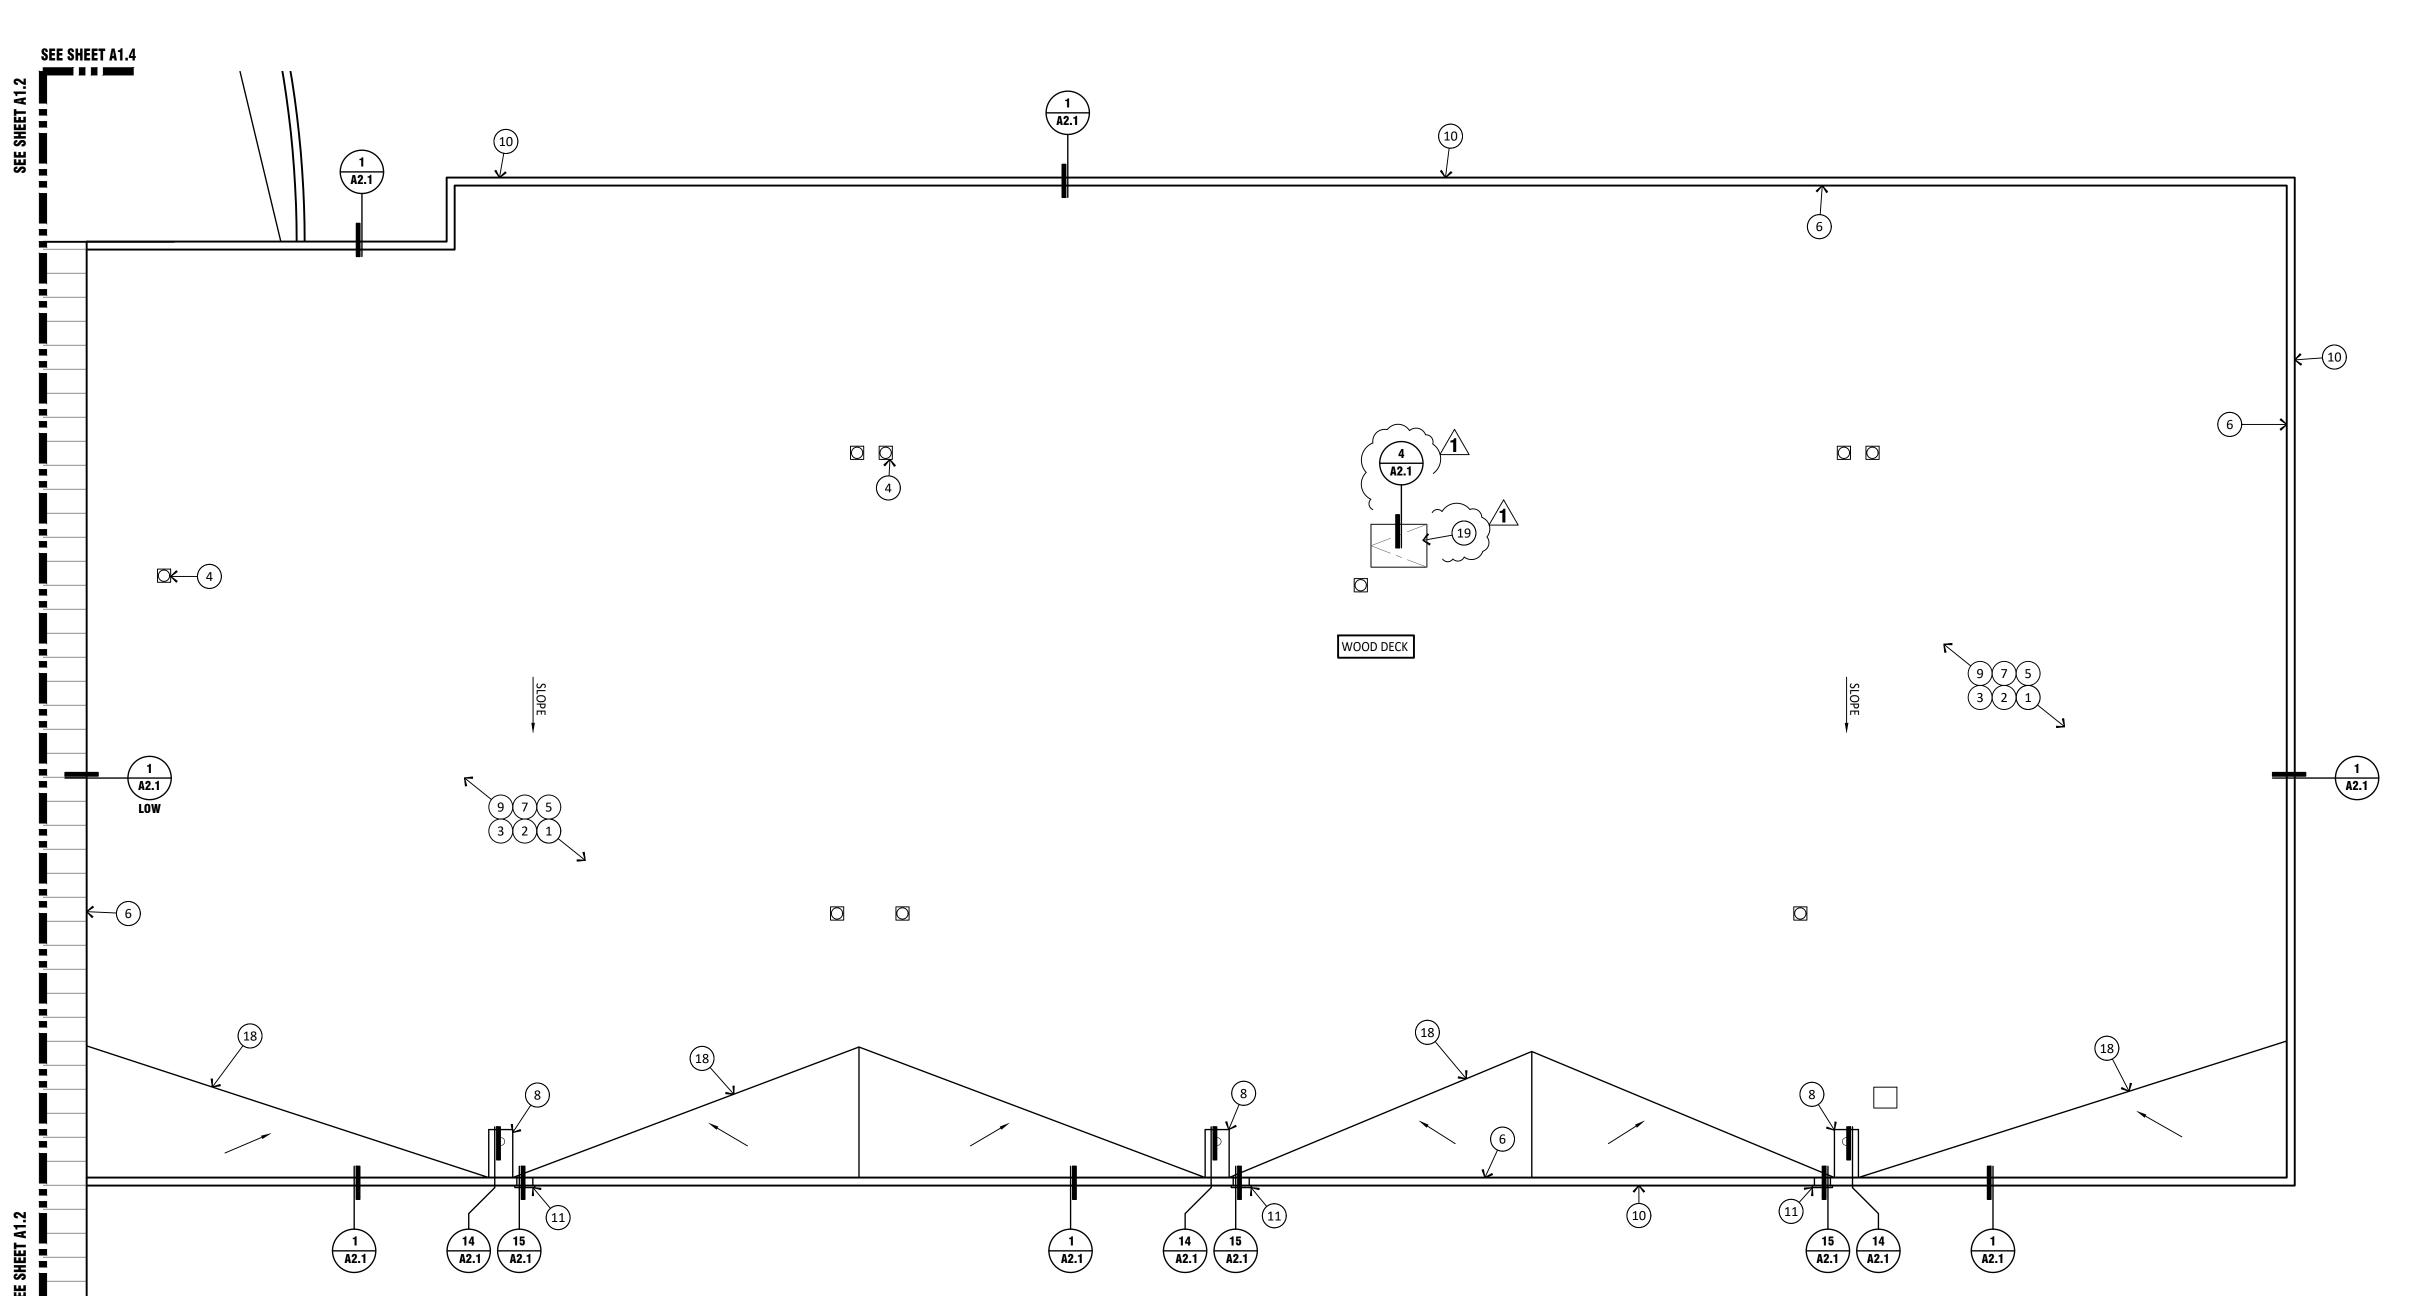
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OCOTILLO OVERALL ROOF PLAN

A1.0





- REMOVE EXISTING ROOFING SYSTEM TO DECK. CLEAN AND PREP DECK AS REQUIRED FOR NEW ROOF SEE SPECIFICATIONS
- 2. INSTALL NEW ROOFING ON COVER BOARD OVER RIGID INSULATION. TYPICAL SEE SPECIFICATIONS.
- 3. REMOVE AND REPLACE ALL METAL FLASHINGS, REGLETS, AND COUNTER FLASHINGS TYPICAL SEE
- 4. PROVIDE NEW FLASHING AT MECHANICAL CURBS. ENSURE CONDENSATE LINES ARE PROPERLY SUPPORTED. REMOVE AND REPLACE DUCT SEALANTS. SEE SPECIFICATIONS TYPICAL
- 5. REMOVE EXISTING SLEEPERS UNDER CONDUIT AND PIPE. PROTECT DURING CONSTRUCTION ACTIVITIES. PROVIDE NEW DURA-BLOK SUPPORTS TYPICAL
- 6. CLEAN EXISTING PARAPET WALLS ON ROOF SIDE. WRAP WALLS 4'-0" HIGH AND UNDER WITH KEE MEMBRANE THAT EXTENDS UP AND OVER NEW TREATED WOOD SLEEPERS. PROVIDE BLOCK FILL AND COAT PARAPET WALLS TALLER THAN 4'-0" TO BOTTOM OF COPING - SEE SPECIFICATIONS
- 7. REMOVE ALL CONSTRUCTION JOINT CAULKING FROM ROOF SIDE OF PARAPET AND REPLACE PER SPECIFICATIONS
- 8. PROVIDE NEW SUMPS AS REQUIRED AT EXISTING SCUPPER LOCATIONS. CLEAR ALL DRAIN LEADERS AND ENSURE PROPER OPERATION SEE SPECIFICATIONS TYPICAL
- 9. RAISE DUCT AS REQUIRED FOR PROPER FLASHING -
- 10. PROVIDE NEW TREATED WOOD NAILERS AND METAL COPING CAPS PER SPECIFICATIONS
- 11. PROVIDE NEW SHEET METAL SCUPPERS
- 12. CLEAR SCUPPERS OF DEBRIS AND ENSURE PROPER OPERATION.
- 13. PROVIDE REPAIRS TO LAPS, SEAMS, RIVETS, PENETRATIONS AND OTHERS AS REQUIRED ON METAL ROOFS. VERIFY IN FIELD. SEE SPECIFICATIONS
- 14. PROVIDE REPAIRS AS REQUIRED VERIFY IN FIELD
- 15. CLEAN ROOF AND PROVIDE NEW COATING SEE SPECIFICATIONS
- 16. CLEAR ROOF DRAINS AND ENSURE PROPER OPERATION
- 17. PROVIDE NEW CONCRETE SPLASH BLOCKS WHERE
- 18. NEW CRICKETS SIZE TO ENSURE PROPER DRAINAGE
- 19. PROVIDE NEW ROOF HATCH PROVIDE SUBMITTAL TO ARCHITECT.
- 20. PROVIDE NEW STEEL ROOF ACCESS LADDER PROVIDE SHOP DRAWING TO ARCHITECT SEE
- DETAIL 1/A1.5 I. REMOVE ALL MECH EQUIPMENT. PROVIDE NEW ROOFING AND FLASHING. REINSTALL ALL EQUIPMENT ON NEW CURB. PROVIDE MECHANICAL, PLUMBING AND MECHANICAL WORK AS REQUIRED TO REMOVE AND REINSTALL SYSTEM. VERIFY PROPER OPERATION AND STARTS UP.

GENERAL NOTES

- A. CONTRACTOR TO REVIEW SPECIFICATIONS PRIOR TO BID. NOTIFY ARCHITECT OF ANY CONFLICTS.
- B. KEYNOTES ARE TYPICAL THROUGHOUT
- ANY INCIDENTAL MECHANICAL, PLUMBING OR ELECTRICAL ASSOCIATED WITH ROOFTOP EQUIPMENT SHALL BE PERFORMED BY PROPER LICENSED SUBCONTRACTORS UNDER THIS ROOFING CONTRACT - ALL WORK SHALL BE PERFORMED TO CURRENT CODES
- D. ADJUST EXISTING ELECTRICAL CONDUIT,
 CONDENSATE AND UTILITY LINES AS REQUIRED FOR NEW ROOF HEIGHT. PROVIDE NEW DURA BLOK SUPPORTS - TYPICAL - SEE SPECIFICATIONS.
- E. REMOVE EXISTING LOW VOLTAGE WIRE AND REINSTALL AFTER ROOF REPLACEMENT
- F. REMOVE AND PATCH ALL ABANDONED OPENINGS. NOTIFY ARCHITECT IF OPENING IS WIDER THAN 12' X 12"
- G. REMOVE AND REPLACE EXISTING LIGHTNING PROTECTION SYSTEM. NEW SYSTEM TO BE RE CERTIFIED
- H. DEMO ALL ABANDONED PITCH PANS. CAP WATER AND POWER

TYPICAL DETAILS THROUGHOUT

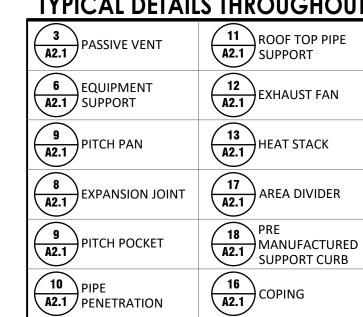

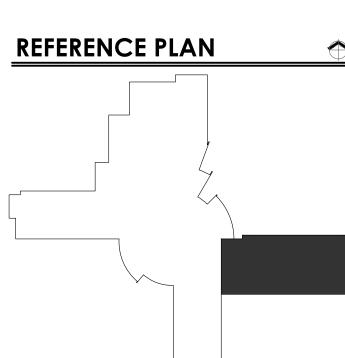

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602.347.5226


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PROJECT NO.:		ECT NO.	<u>: 21165</u>	
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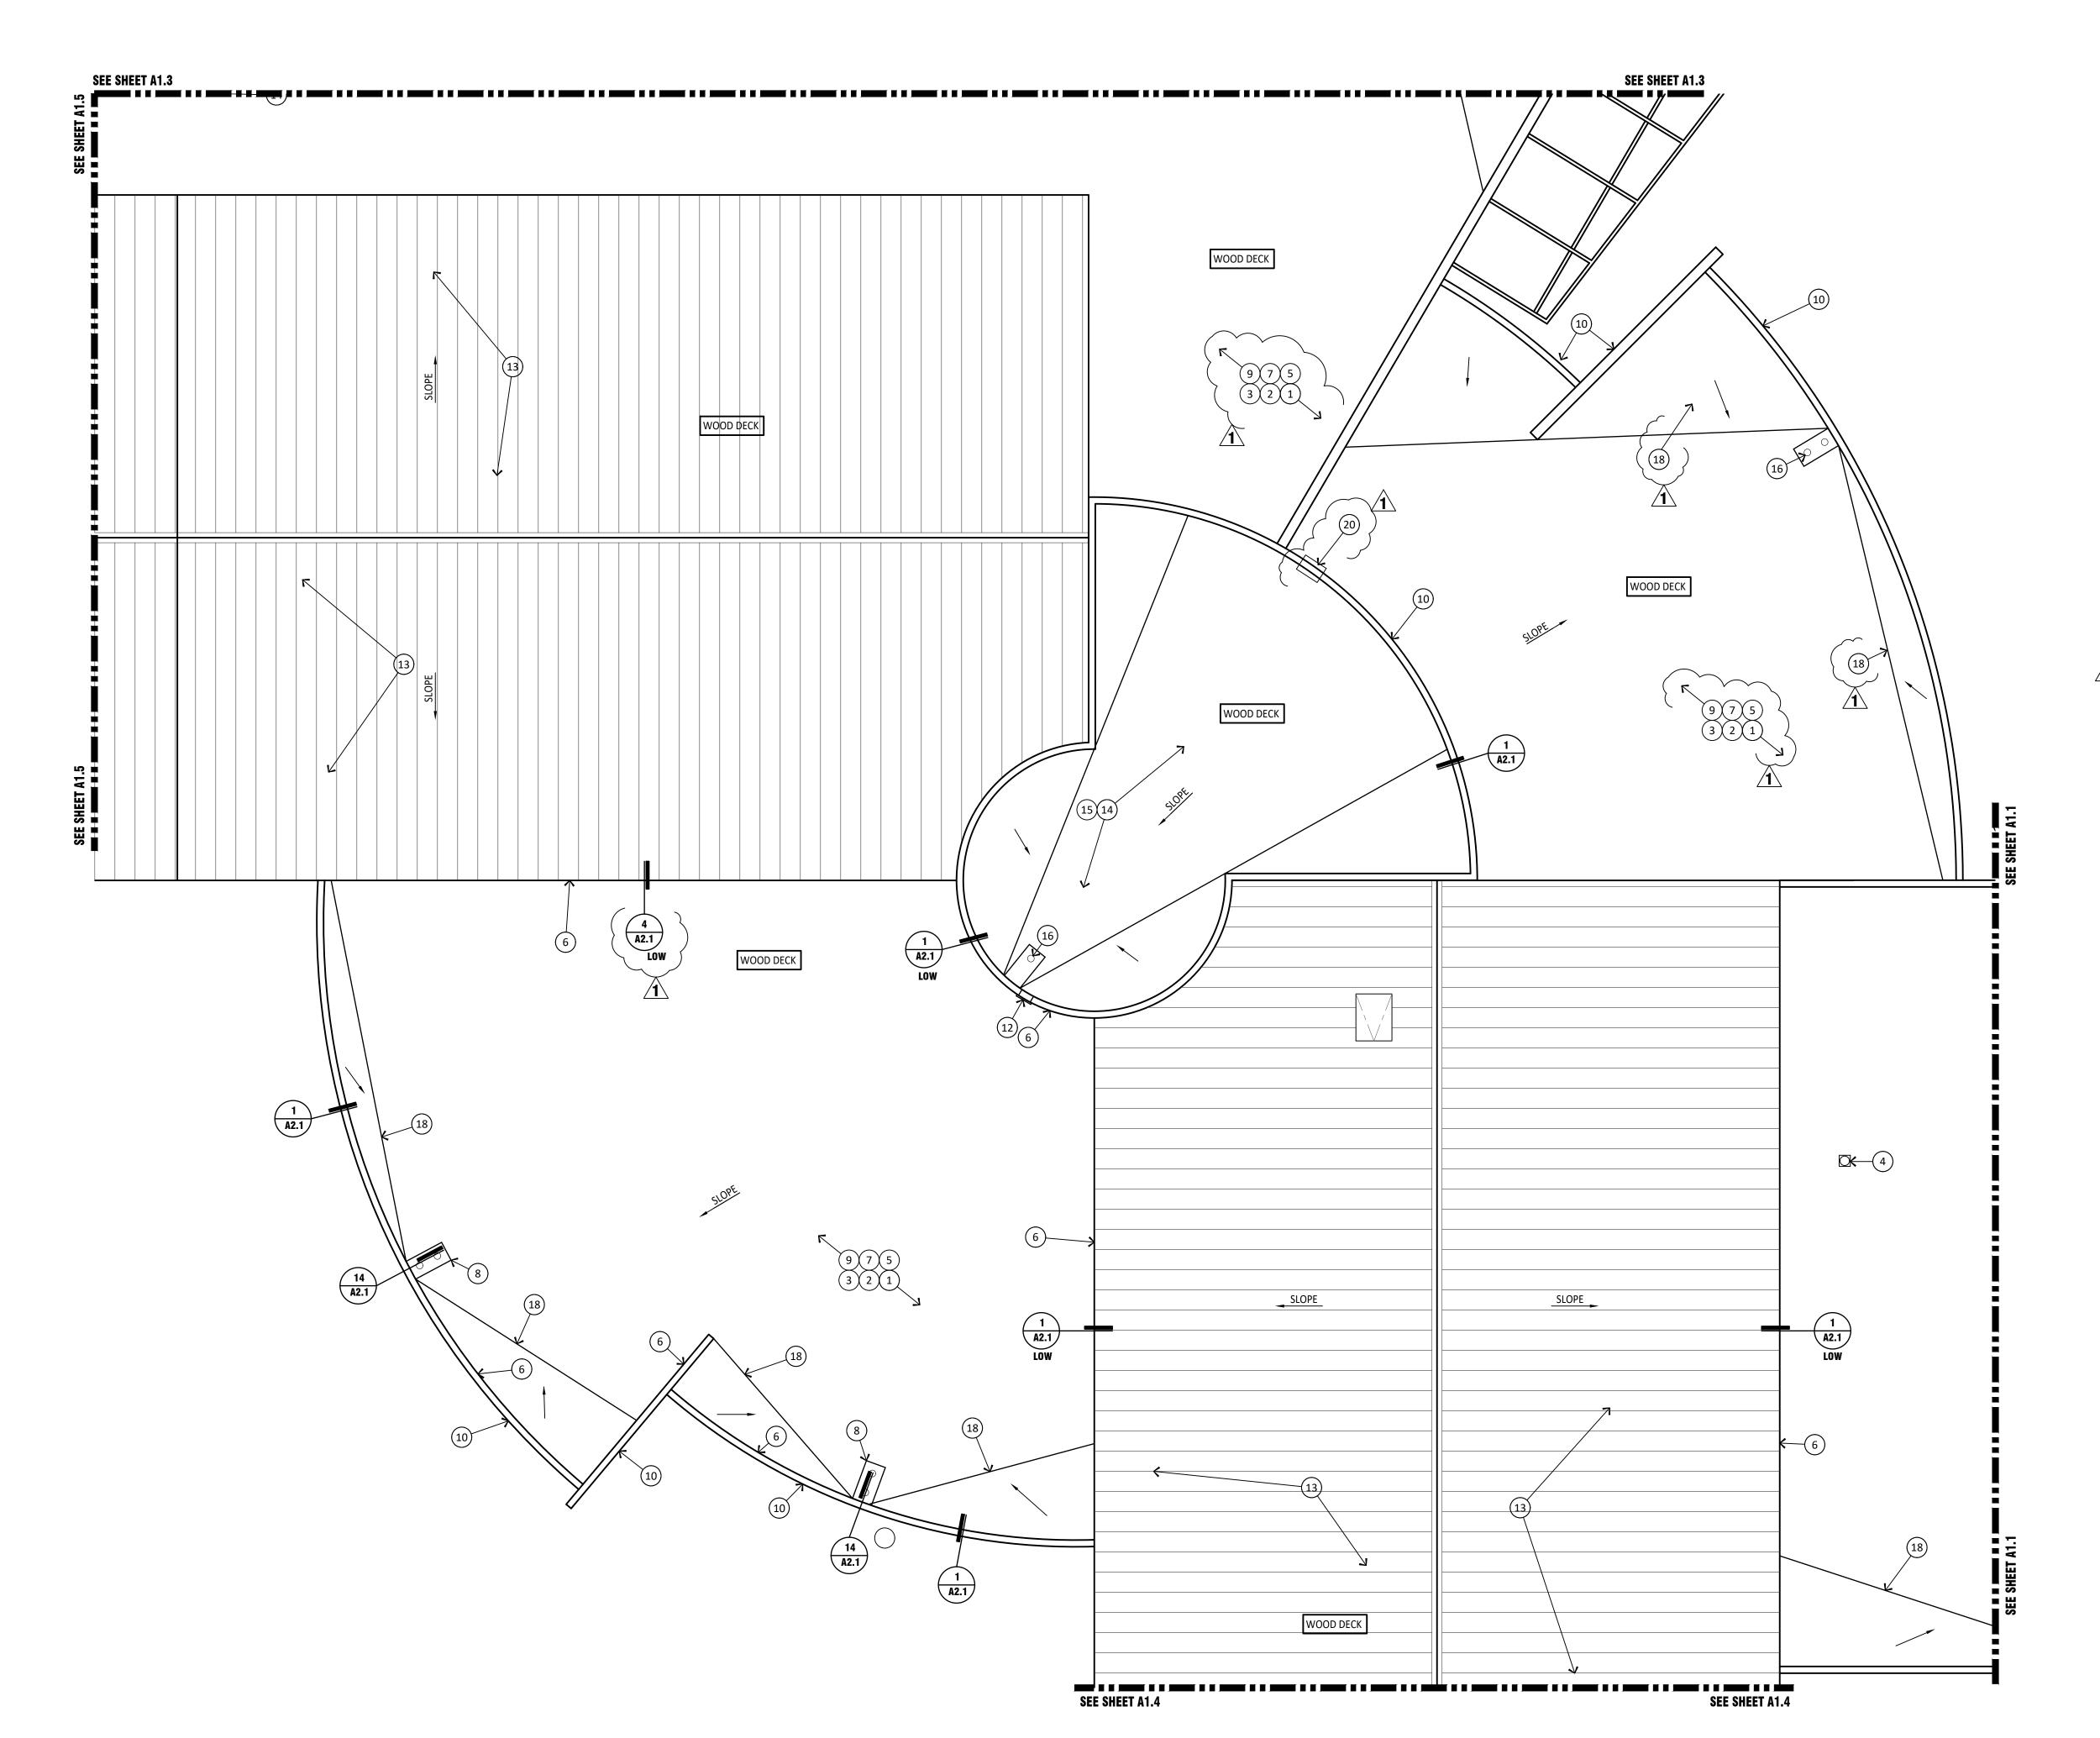
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BUILDING E (SFB 1017) ROOF PLAN

SEE SHEET A1.2

SEE SHEET A1.2



- REMOVE EXISTING ROOFING SYSTEM TO DECK. CLEAN AND PREP DECK AS REQUIRED FOR NEW ROOF SEE SPECIFICATIONS
- 2. INSTALL NEW ROOFING ON COVER BOARD OVER RIGID INSULATION. TYPICAL SEE SPECIFICATIONS.
- 3. REMOVE AND REPLACE ALL METAL FLASHINGS, REGLETS, AND COUNTER FLASHINGS TYPICAL SEE SPECIFICATIONS.
- 4. PROVIDE NEW FLASHING AT MECHANICAL CURBS. ENSURE CONDENSATE LINES ARE PROPERLY SUPPORTED. REMOVE AND REPLACE DUCT SEALANTS. SEE SPECIFICATIONS TYPICAL
- 5. REMOVE EXISTING SLEEPERS UNDER CONDUIT AND PIPE. PROTECT DURING CONSTRUCTION ACTIVITIES. PROVIDE NEW DURA-BLOK SUPPORTS TYPICAL
- 6. CLEAN EXISTING PARAPET WALLS ON ROOF SIDE. WRAP WALLS 4'-0" HIGH AND UNDER WITH KEE MEMBRANE THAT EXTENDS UP AND OVER NEW TREATED WOOD SLEEPERS. PROVIDE BLOCK FILL AND COAT PARAPET WALLS TALLER THAN 4'-0" TO BOTTOM OF COPING - SEE SPECIFICATIONS
- 7. REMOVE ALL CONSTRUCTION JOINT CAULKING FROM ROOF SIDE OF PARAPET AND REPLACE PER SPECIFICATIONS
- 8. PROVIDE NEW SUMPS AS REQUIRED AT EXISTING SCUPPER LOCATIONS. CLEAR ALL DRAIN LEADERS AND ENSURE PROPER OPERATION SEE SPECIFICATIONS TYPICAL
- 9. RAISE DUCT AS REQUIRED FOR PROPER FLASHING -
- 10. PROVIDE NEW TREATED WOOD NAILERS AND METAL COPING CAPS PER SPECIFICATIONS
- 11. PROVIDE NEW SHEET METAL SCUPPERS
- 12. CLEAR SCUPPERS OF DEBRIS AND ENSURE PROPER OPERATION.
- 13. PROVIDE REPAIRS TO LAPS, SEAMS, RIVETS, PENETRATIONS AND OTHERS AS REQUIRED ON METAL ROOFS. VERIFY IN FIELD. SEE SPECIFICATIONS
- 14. PROVIDE REPAIRS AS REQUIRED VERIFY IN FIELD
- 15. CLEAN ROOF AND PROVIDE NEW COATING SEE SPECIFICATIONS
- 16. CLEAR ROOF DRAINS AND ENSURE PROPER OPERATION
- 17. PROVIDE NEW CONCRETE SPLASH BLOCKS WHERE
- 18. NEW CRICKETS SIZE TO ENSURE PROPER DRAINAGE
- 19. PROVIDE NEW ROOF HATCH PROVIDE SUBMITTAL TO ARCHITECT.
- 20. PROVIDE NEW STEEL ROOF ACCESS LADDER PROVIDE SHOP DRAWING TO ARCHITECT SEE
 - 21. REMOVE ALL MECH EQUIPMENT. PROVIDE NEW ROOFING AND FLASHING. REINSTALL ALL EQUIPMENT ON NEW CURB. PROVIDE MECHANICAL, PLUMBING AND MECHANICAL WORK AS REQUIRED TO REMOVE AND REINSTALL SYSTEM. VERIFY PROPER OPERATION AND STARTS UP.

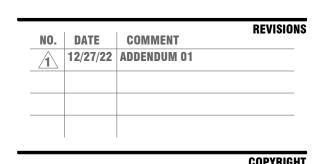
GENERAL NOTES

DETAIL 1/A1.5

- CONTRACTOR TO REVIEW SPECIFICATIONS PRIOR TO BID. NOTIFY ARCHITECT OF ANY CONFLICTS.
- B. KEYNOTES ARE TYPICAL THROUGHOUT
- ANY INCIDENTAL MECHANICAL, PLUMBING OR ELECTRICAL ASSOCIATED WITH ROOFTOP EQUIPMENT SHALL BE PERFORMED BY PROPER LICENSED SUBCONTRACTORS UNDER THIS ROOFING CONTRACT - ALL WORK SHALL BE PERFORMED TO CURRENT CODES
- D. ADJUST EXISTING ELECTRICAL CONDUIT,
 CONDENSATE AND UTILITY LINES AS REQUIRED FOR NEW ROOF HEIGHT. PROVIDE NEW DURA BLOK SUPPORTS - TYPICAL - SEE SPECIFICATIONS.
- E. REMOVE EXISTING LOW VOLTAGE WIRE AND REINSTALL AFTER ROOF REPLACEMENT
- REMOVE AND PATCH ALL ABANDONED OPENINGS. NOTIFY ARCHITECT IF OPENING IS WIDER THAN 12' X 12"
- G. REMOVE AND REPLACE EXISTING LIGHTNING PROTECTION SYSTEM. NEW SYSTEM TO BE RE CERTIFIED
- H. DEMO ALL ABANDONED PITCH PANS. CAP WATER AND POWER

TYPICAL DETAILS THROUGHOUT



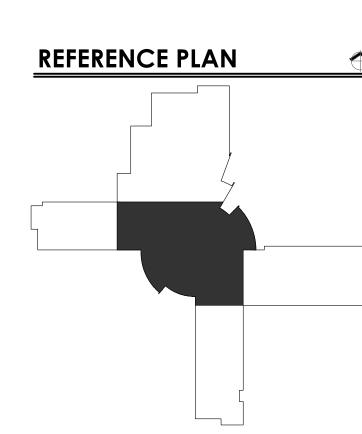


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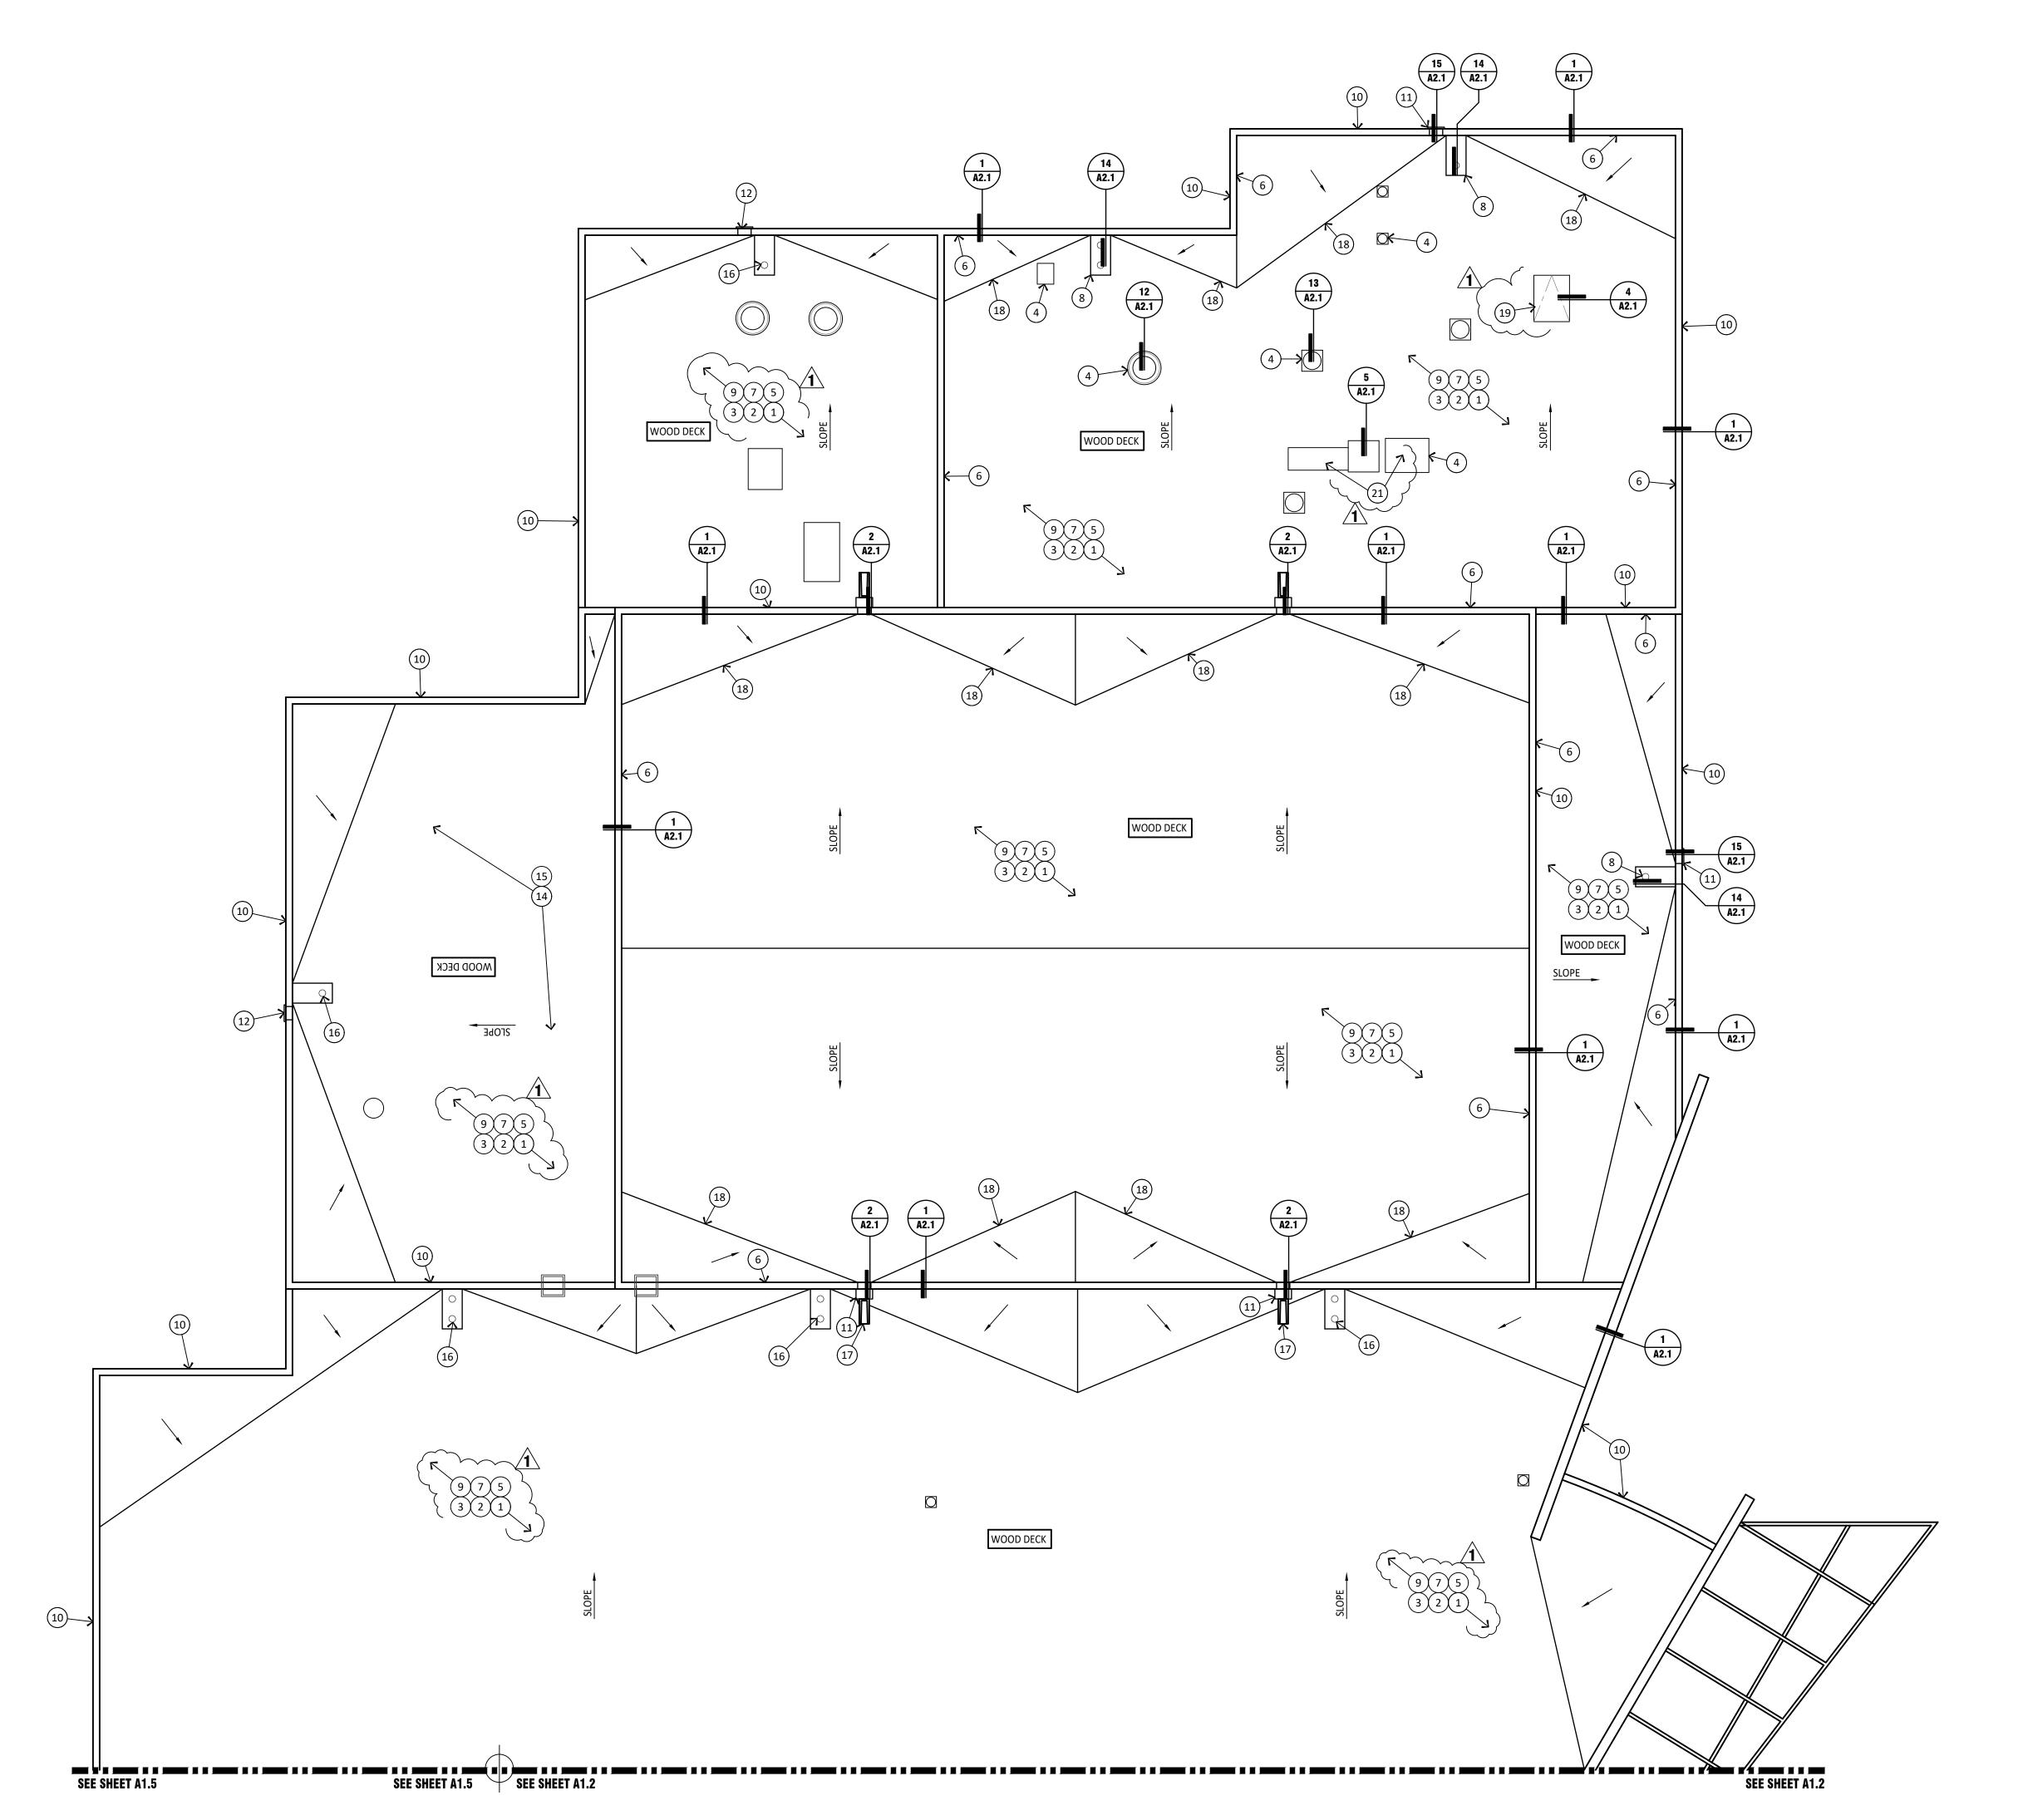
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DRAWING TITLE

BUILDING A (SFB 1013) **ROOF PLAN**



- REMOVE EXISTING ROOFING SYSTEM TO DECK. CLEAN AND PREP DECK AS REQUIRED FOR NEW ROOF SEE SPECIFICATIONS
- 2. INSTALL NEW ROOFING ON COVER BOARD OVER RIGID INSULATION. TYPICAL SEE SPECIFICATIONS.
- 3. REMOVE AND REPLACE ALL METAL FLASHINGS, REGLETS, AND COUNTER FLASHINGS TYPICAL SEE SPECIFICATIONS.
- 4. PROVIDE NEW FLASHING AT MECHANICAL CURBS. ENSURE CONDENSATE LINES ARE PROPERLY SUPPORTED. REMOVE AND REPLACE DUCT SEALANTS. SEE SPECIFICATIONS TYPICAL
- 5. REMOVE EXISTING SLEEPERS UNDER CONDUIT AND PIPE. PROTECT DURING CONSTRUCTION ACTIVITIES. PROVIDE NEW DURA-BLOK SUPPORTS TYPICAL
- 6. CLEAN EXISTING PARAPET WALLS ON ROOF SIDE. WRAP WALLS 4'-0" HIGH AND UNDER WITH KEE MEMBRANE THAT EXTENDS UP AND OVER NEW TREATED WOOD SLEEPERS. PROVIDE BLOCK FILL AND COAT PARAPET WALLS TALLER THAN 4'-0" TO BOTTOM OF COPING - SEE SPECIFICATIONS
- 7. REMOVE ALL CONSTRUCTION JOINT CAULKING FROM ROOF SIDE OF PARAPET AND REPLACE PER SPECIFICATIONS
- 8. PROVIDE NEW SUMPS AS REQUIRED AT EXISTING SCUPPER LOCATIONS. CLEAR ALL DRAIN LEADERS AND ENSURE PROPER OPERATION SEE SPECIFICATIONS TYPICAL
- 9. RAISE DUCT AS REQUIRED FOR PROPER FLASHING -
- 10. PROVIDE NEW TREATED WOOD NAILERS AND METAL COPING CAPS PER SPECIFICATIONS
- 11. PROVIDE NEW SHEET METAL SCUPPERS
- 12. CLEAR SCUPPERS OF DEBRIS AND ENSURE PROPER OPERATION.
- 13. PROVIDE REPAIRS TO LAPS, SEAMS, RIVETS, PENETRATIONS AND OTHERS AS REQUIRED ON METAL ROOFS. VERIFY IN FIELD. SEE SPECIFICATIONS
- 14. PROVIDE REPAIRS AS REQUIRED VERIFY IN FIELD
- 15. CLEAN ROOF AND PROVIDE NEW COATING SEE SPECIFICATIONS
- 16. CLEAR ROOF DRAINS AND ENSURE PROPER OPERATION
- 17. PROVIDE NEW CONCRETE SPLASH BLOCKS WHERE REQUIRED.
- 18. NEW CRICKETS SIZE TO ENSURE PROPER DRAINAGE
- 19. PROVIDE NEW ROOF HATCH PROVIDE SUBMITTAL TO ARCHITECT.
 - 20. PROVIDE NEW STEEL ROOF ACCESS LADDER PROVIDE SHOP DRAWING TO ARCHITECT SEE
 - 21. REMOVE ALL MECH EQUIPMENT. PROVIDE NEW ROOFING AND FLASHING. REINSTALL ALL EQUIPMENT ON NEW CURB. PROVIDE MECHANICAL, PLUMBING AND MECHANICAL WORK AS REQUIRED TO REMOVE AND REINSTALL SYSTEM. VERIFY PROPER OPERATION AND STARTS UP.

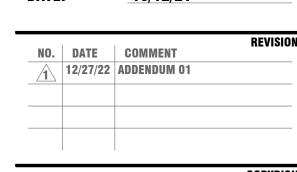
GENERAL NOTES

DETAIL 1/A1.5

- A. CONTRACTOR TO REVIEW SPECIFICATIONS PRIOR TO BID. NOTIFY ARCHITECT OF ANY CONFLICTS.
- B. KEYNOTES ARE TYPICAL THROUGHOUT
- ANY INCIDENTAL MECHANICAL, PLUMBING OR ELECTRICAL ASSOCIATED WITH ROOFTOP EQUIPMENT SHALL BE PERFORMED BY PROPER LICENSED SUBCONTRACTORS UNDER THIS ROOFING CONTRACT - ALL WORK SHALL BE PERFORMED TO CURRENT CODES
- D. ADJUST EXISTING ELECTRICAL CONDUIT,
 CONDENSATE AND UTILITY LINES AS REQUIRED FOR NEW ROOF HEIGHT. PROVIDE NEW DURA BLOK SUPPORTS - TYPICAL - SEE SPECIFICATIONS.
- REMOVE EXISTING LOW VOLTAGE WIRE AND REINSTALL AFTER ROOF REPLACEMENT
- REMOVE AND PATCH ALL ABANDONED OPENINGS. NOTIFY ARCHITECT IF OPENING IS WIDER THAN 12' X 12"
- G. REMOVE AND REPLACE EXISTING LIGHTNING PROTECTION SYSTEM. NEW SYSTEM TO BE RE CERTIFIED
- H. DEMO ALL ABANDONED PITCH PANS. CAP WATER AND POWER

TYPICAL DETAILS THROUGHOUT



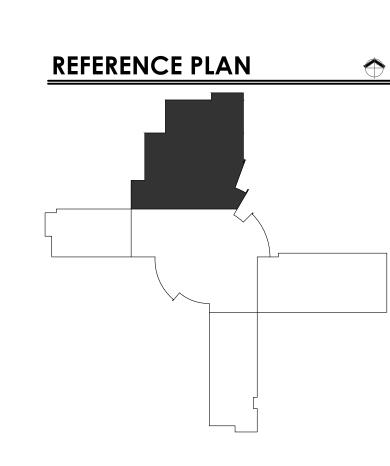

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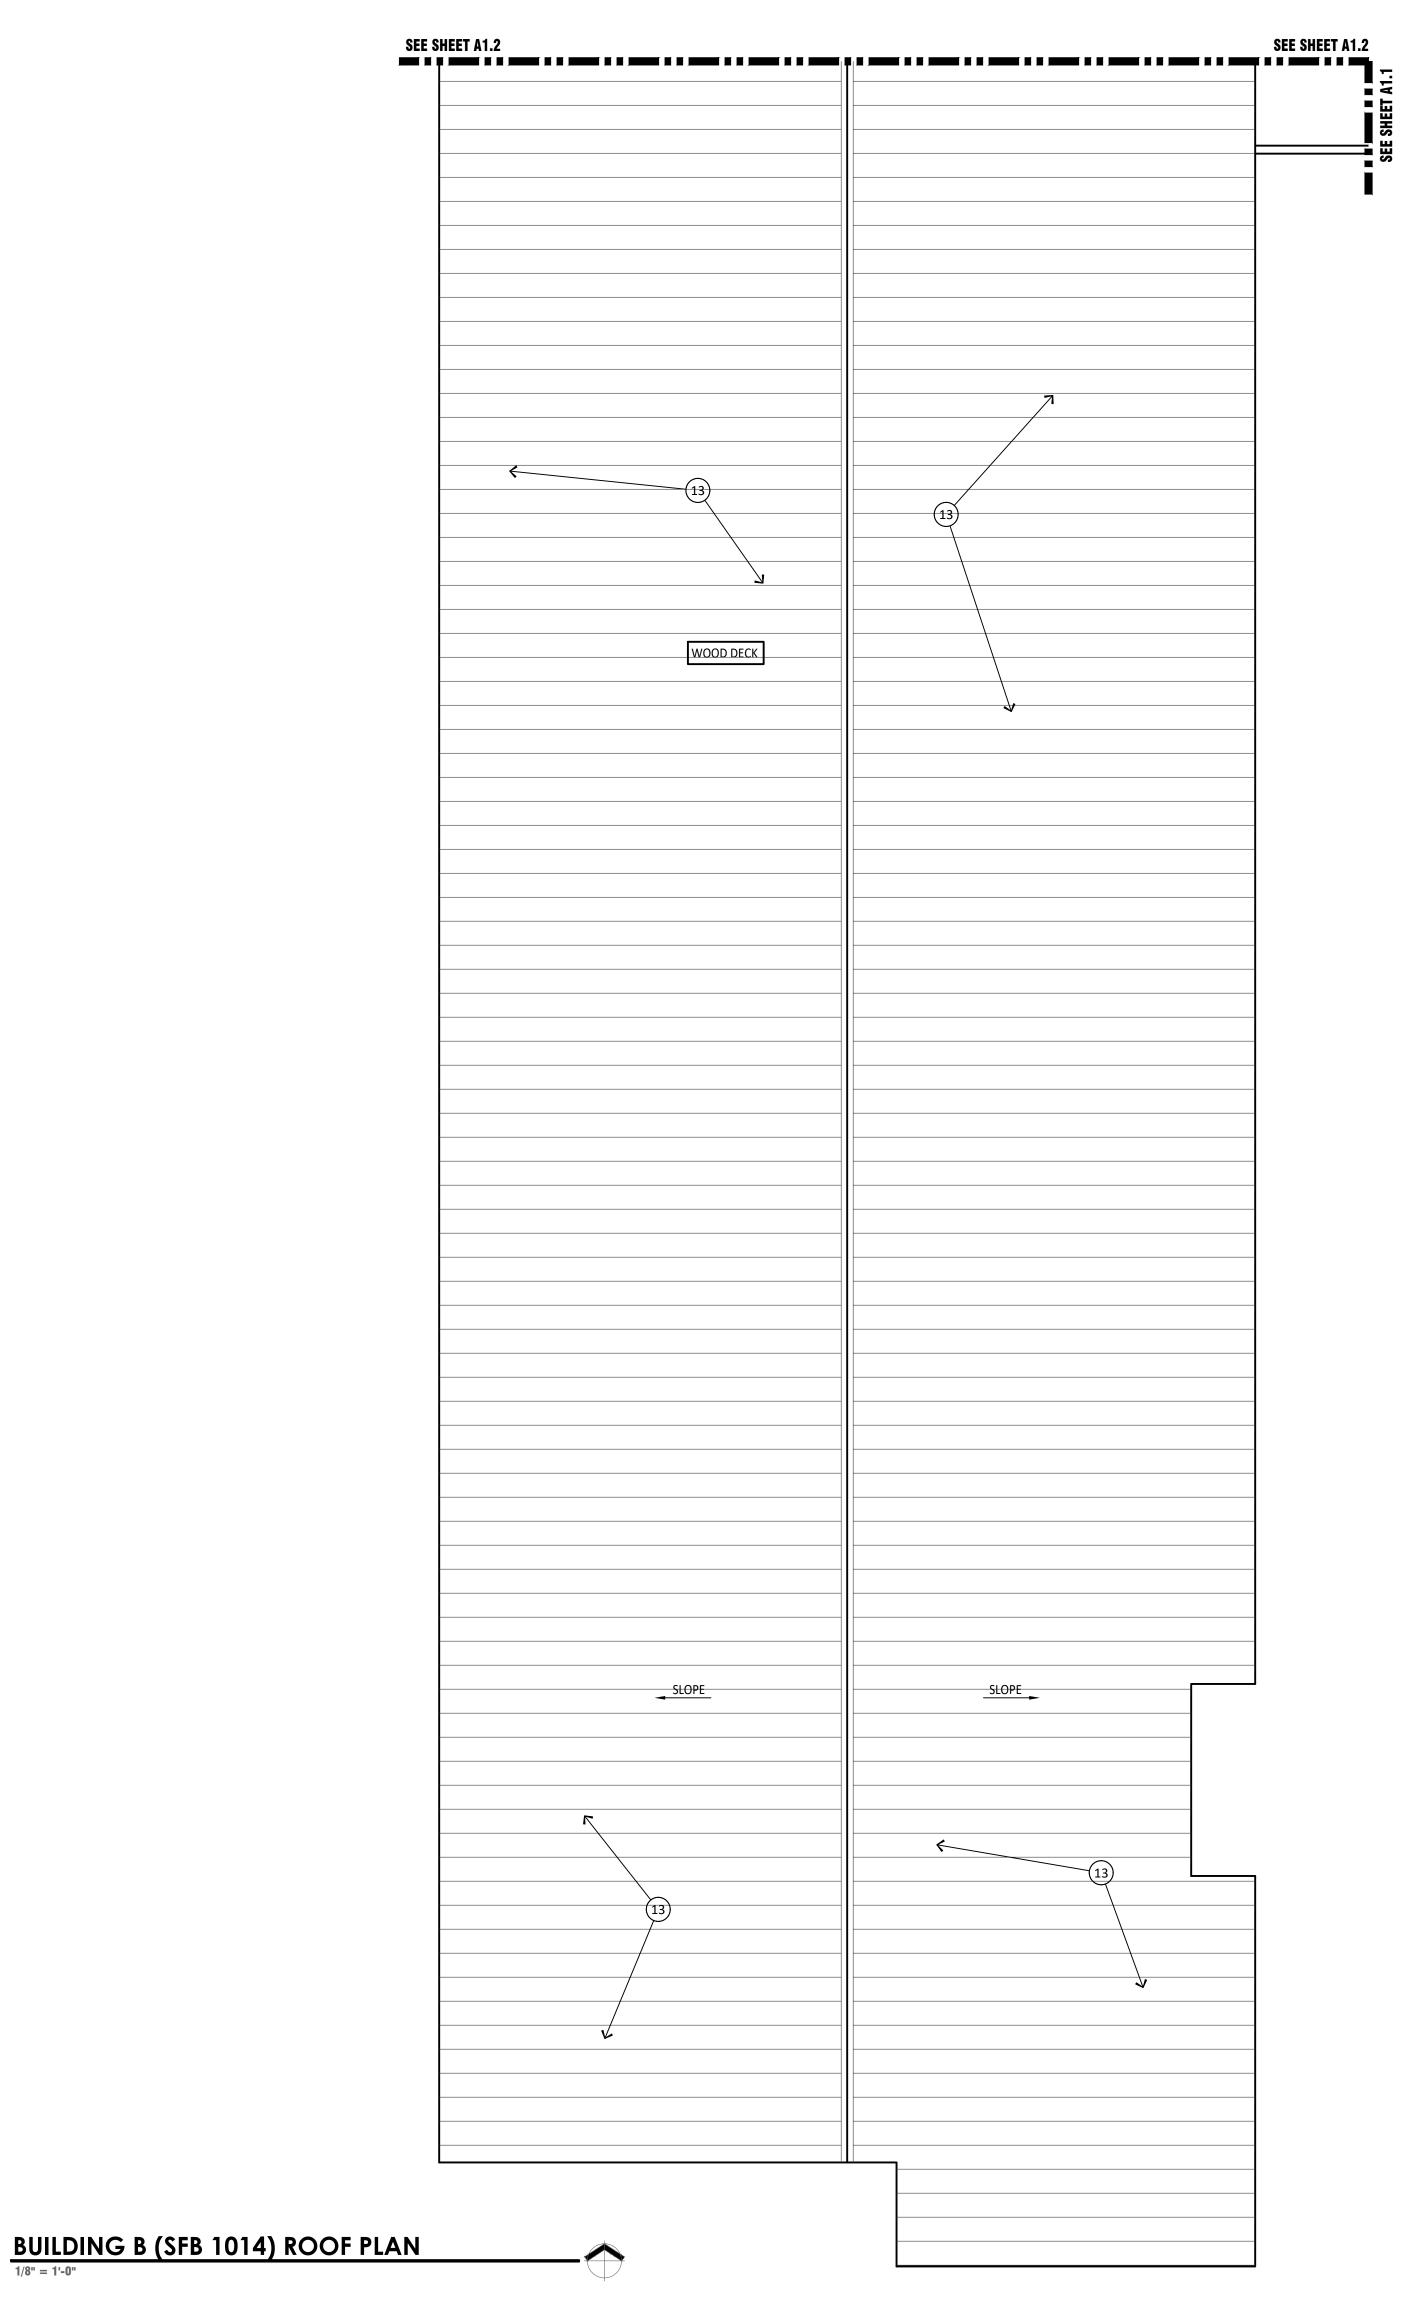
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ROOF PLAN

BUILDING D (SFB 1016)





- REMOVE EXISTING ROOFING SYSTEM TO DECK. CLEAN AND PREP DECK AS REQUIRED FOR NEW ROOF SEE SPECIFICATIONS
- 2. INSTALL NEW ROOFING ON COVER BOARD OVER RIGID INSULATION. TYPICAL SEE SPECIFICATIONS.
- REMOVE AND REPLACE ALL METAL FLASHINGS, REGLETS, AND COUNTER FLASHINGS TYPICAL SEE SPECIFICATIONS.
- 4. PROVIDE NEW FLASHING AT MECHANICAL CURBS. ENSURE CONDENSATE LINES ARE PROPERLY SUPPORTED. REMOVE AND REPLACE DUCT SEALANTS. SEE SPECIFICATIONS TYPICAL
- 5. REMOVE EXISTING SLEEPERS UNDER CONDUIT AND PIPE. PROTECT DURING CONSTRUCTION ACTIVITIES. PROVIDE NEW DURA-BLOK SUPPORTS TYPICAL
- 6. CLEAN EXISTING PARAPET WALLS ON ROOF SIDE. WRAP WALLS 4'-0" HIGH AND UNDER WITH KEE MEMBRANE THAT EXTENDS UP AND OVER NEW TREATED WOOD SLEEPERS. PROVIDE BLOCK FILL AND COAT PARAPET WALLS TALLER THAN 4'-0" TO BOTTOM OF COPING - SEE SPECIFICATIONS
- REMOVE ALL CONSTRUCTION JOINT CAULKING FROM ROOF SIDE OF PARAPET AND REPLACE PER SPECIFICATIONS
- 8. PROVIDE NEW SUMPS AS REQUIRED AT EXISTING SCUPPER LOCATIONS. CLEAR ALL DRAIN LEADERS AND ENSURE PROPERTY OPERATION SEE SPECIFICATIONS - TYPICAL
- 9. RAISE DUCT AS REQUIRED FOR PROPER FLASHING -
- 10. PROVIDE NEW TREATED WOOD NAILERS AND METAL COPING CAPS PER SPECIFICATIONS
- 11. PROVIDE NEW SHEET METAL SCUPPERS
- 12. CLEAR SCUPPERS OF DEBRIS AND ENSURE PROPER OPERATION.
- 13. PROVIDE REPAIRS TO LAPS, SEAMS, RIVETS, PENETRATIONS AND OTHERS AS REQUIRED ON METAL ROOFS. VERIFY IN FIELD. SEE SPECIFICATIONS
- 14. PROVIDE REPAIRS AS REQUIRED VERIFY IN FIELD
- 15. CLEAN ROOF AND PROVIDE NEW COATING SEE SPECIFICATIONS
- 16. CLEAR ROOF DRAINS AND ENSURE PROPER
- 17. PROVIDE NEW CONCRETE SPLASH BLOCKS WHERE
- 18. NEW CRICKETS SIZE TO ENSURE PROPER DRAINAGE
- 19. PROVIDE NEW ROOF HATCH PROVIDE SUBMITTAL 20. PROVIDE NEW STEEL ROOF ACCESS LADDER PROVIDE SHOP DRAWING TO ARCHITECT SEE
- DETAIL 1/A1.5 L. REMOVE ALL MECH EQUIPMENT. PROVIDE NEW ROOFING AND FLASHING. REINSTALL ALL EQUIPMENT ON NEW CURB. PROVIDE MECHANICAL, PLUMBING AND MECHANICAL WORK AS REQUIRED TO REMOVE AND REINSTALL SYSTEM. VERIFY PROPER OPERATION AND STARTS UP.

GENERAL NOTES

- CONTRACTOR TO REVIEW SPECIFICATIONS PRIOR TO BID. NOTIFY ARCHITECT OF ANY CONFLICTS.
- B. KEYNOTES ARE TYPICAL THROUGHOUT
- C. ANY INCIDENTAL MECHANICAL, PLUMBING OR ELECTRICAL ASSOCIATED WITH ROOFTOP EQUIPMENT SHALL BE PERFORMED BY PROPER LICENSED SUBCONTRACTORS UNDER THIS ROOFING CONTRACT - ALL WORK SHALL BE PERFORMED TO CURRENT CODES
- D. ADJUST EXISTING ELECTRICAL CONDUIT,
 CONDENSATE AND UTILITY LINES AS REQUIRED FOR NEW ROOF HEIGHT. PROVIDE NEW DURA BLOK SUPPORTS - TYPICAL - SEE SPECIFICATIONS.
- E. REMOVE EXISTING LOW VOLTAGE WIRE AND REINSTALL AFTER ROOF REPLACEMENT
- F. REMOVE AND PATCH ALL ABANDONED OPENINGS. NOTIFY ARCHITECT IF OPENING IS WIDER THAN 12" X 12"
- G. REMOVE AND REPLACE EXISTING LIGHTNING PROTECTION SYSTEM. NEW SYSTEM TO BE RE CERTIFIED
- H. DEMO ALL ABANDONED PITCH PANS. CAP WATER AND POWER

TYPICAL DETAILS THROUGHOUT

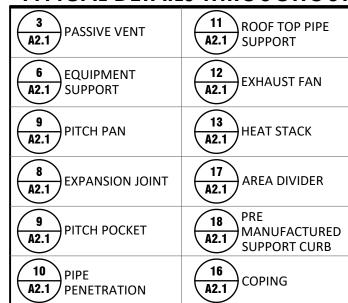

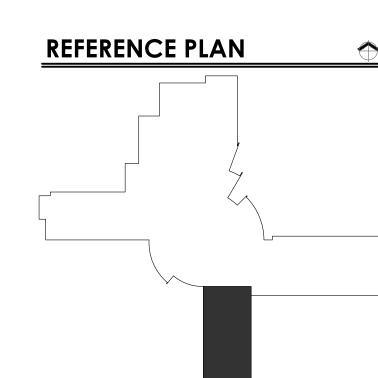

DATE:

10/12/21

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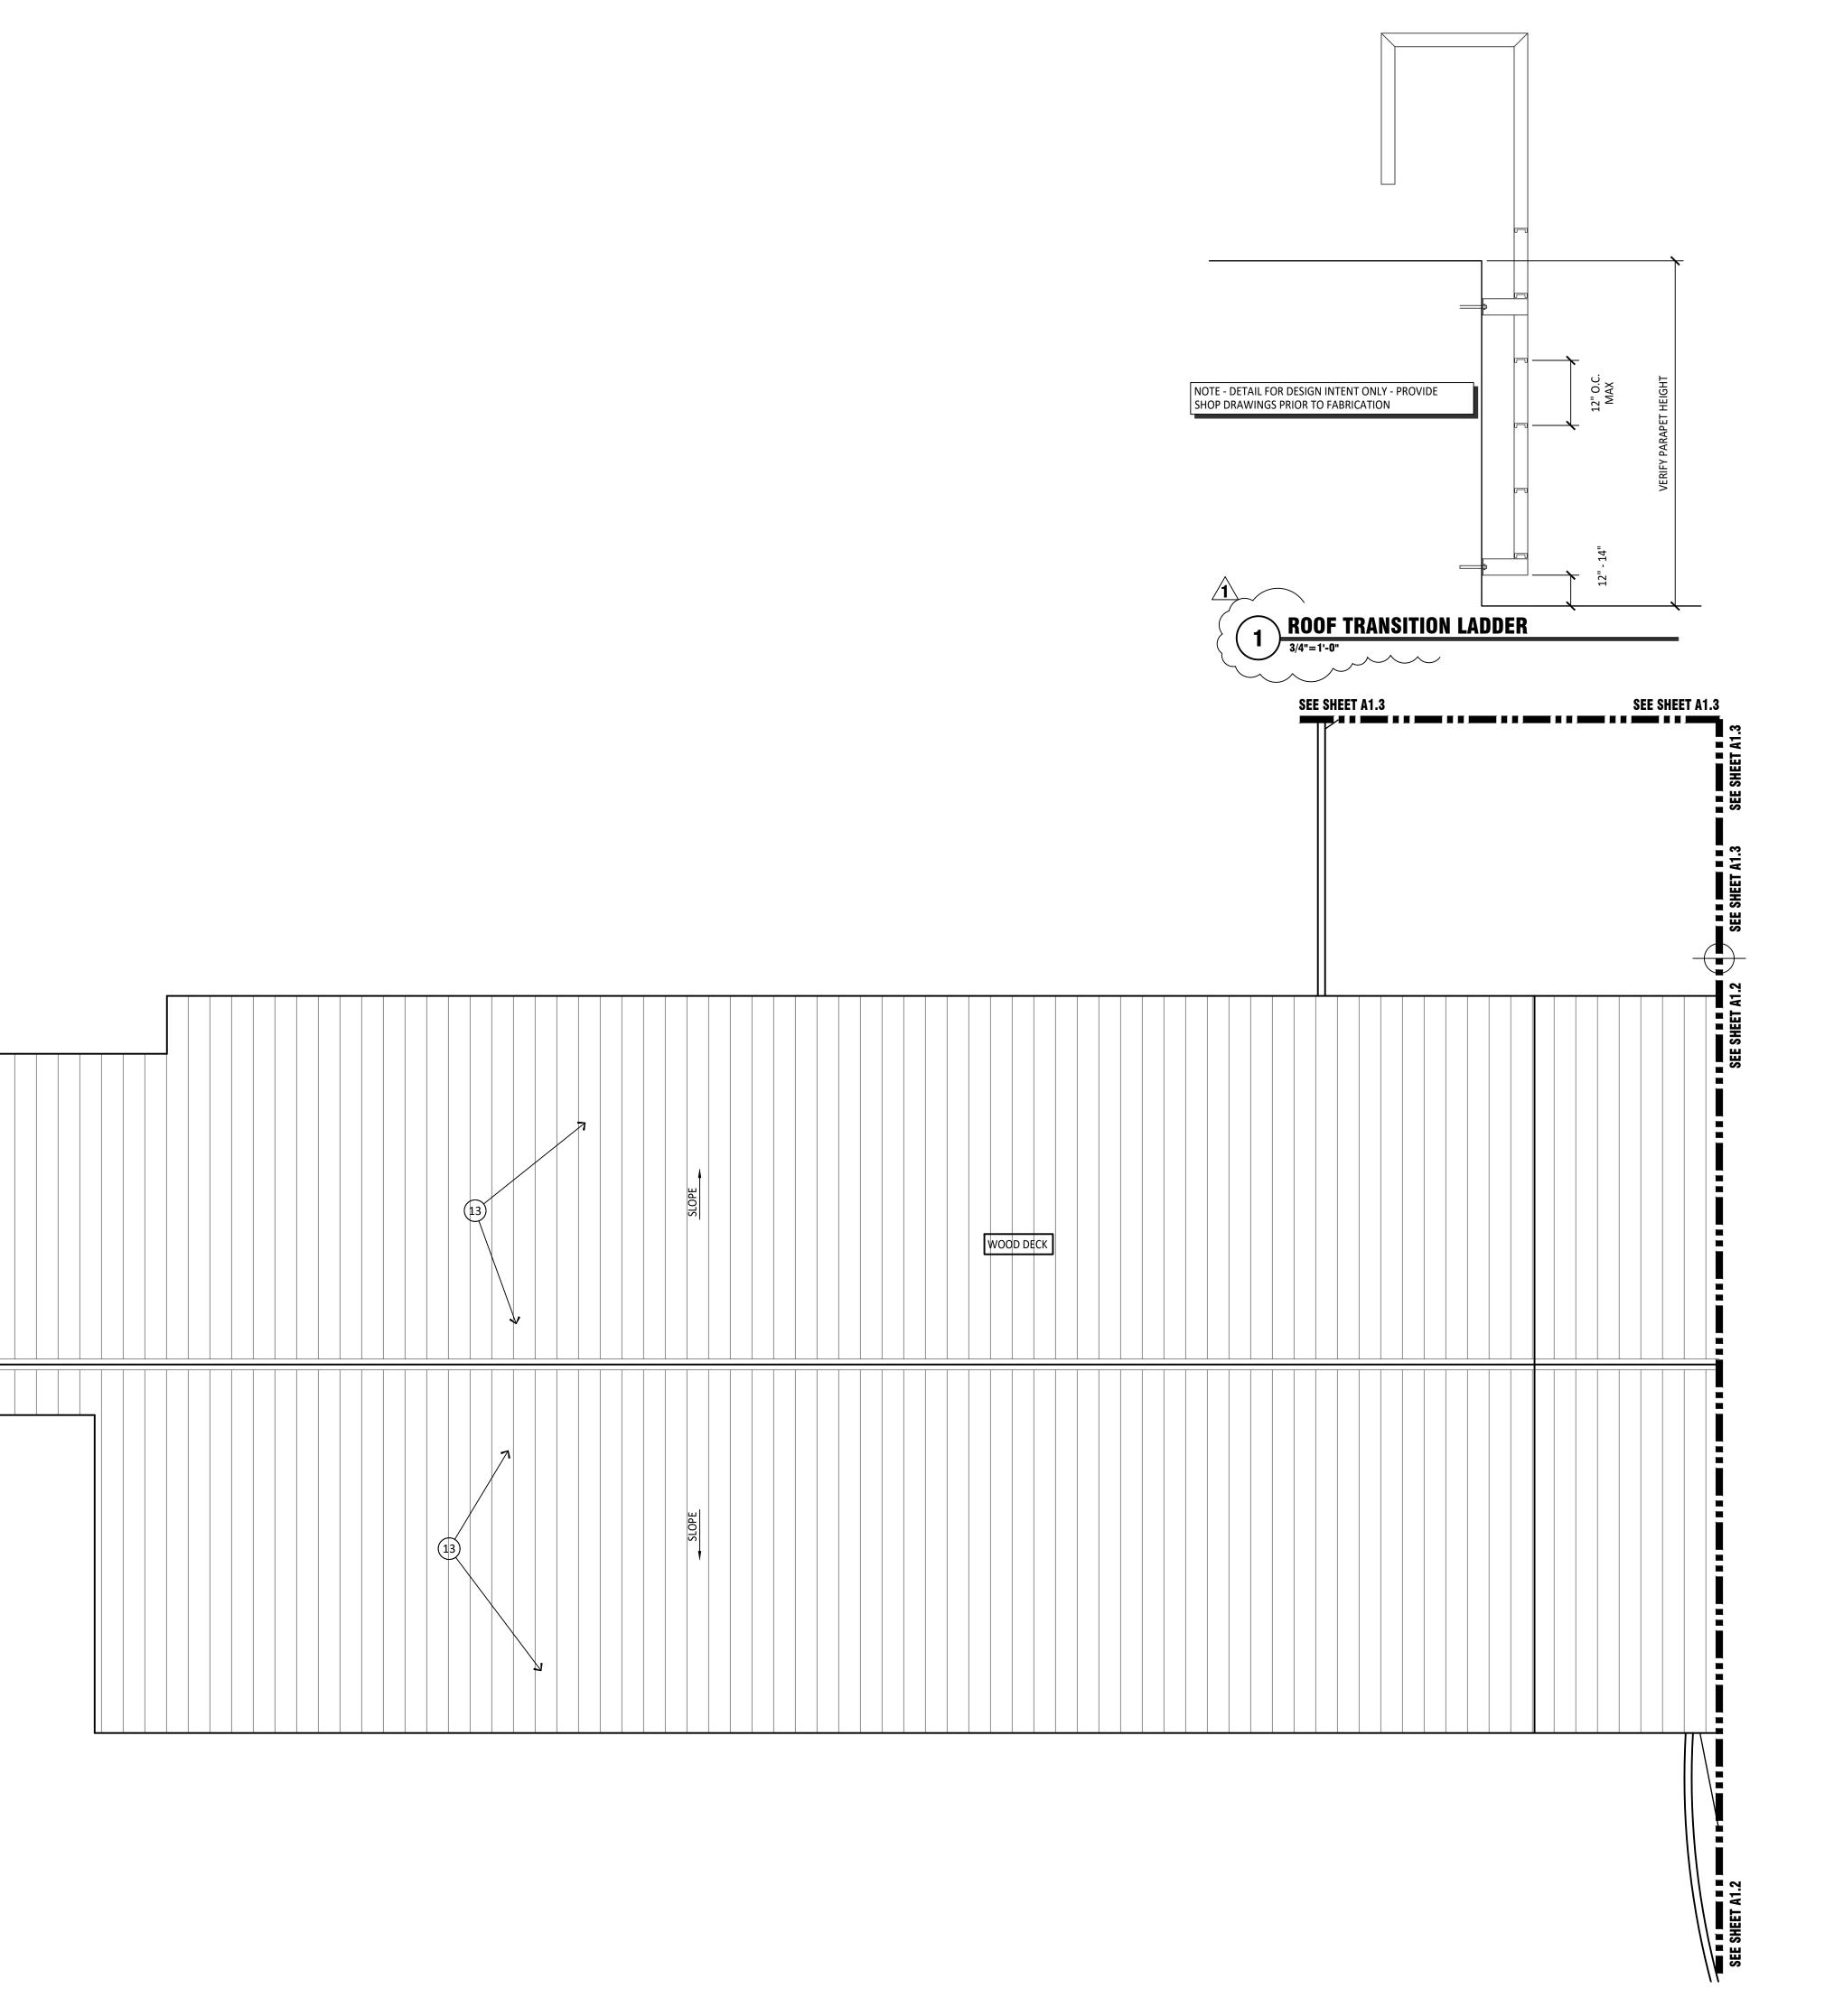
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BUILDING B (SFB 1014) **ROOF PLAN**





- REMOVE EXISTING ROOFING SYSTEM TO DECK. CLEAN AND PREP DECK AS REQUIRED FOR NEW ROOF SEE SPECIFICATIONS
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- 3. REMOVE AND REPLACE ALL METAL FLASHINGS, REGLETS, AND COUNTER FLASHINGS TYPICAL SEE SPECIFICATIONS.
- 4. PROVIDE NEW FLASHING AT MECHANICAL CURBS. ENSURE CONDENSATE LINES ARE PROPERLY SUPPORTED. REMOVE AND REPLACE DUCT SEALANTS. SEE SPECIFICATIONS TYPICAL
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- 6. CLEAN EXISTING PARAPET WALLS ON ROOF SIDE. WRAP WALLS 4'-0" HIGH AND UNDER WITH KEE MEMBRANE THAT EXTENDS UP AND OVER NEW TREATED WOOD SLEEPERS. PROVIDE BLOCK FILL AND COAT PARAPET WALLS TALLER THAN 4'-0" TO BOTTOM OF COPING - SEE SPECIFICATIONS
- 7. REMOVE ALL CONSTRUCTION JOINT CAULKING FROM ROOF SIDE OF PARAPET AND REPLACE PER SPECIFICATIONS
- 8. PROVIDE NEW SUMPS AS REQUIRED AT EXISTING SCUPPER LOCATIONS. CLEAR ALL DRAIN LEADERS AND ENSURE PROPER OPERATION SEE SPECIFICATIONS TYPICAL
- 9. RAISE DUCT AS REQUIRED FOR PROPER FLASHING -
- 10. PROVIDE NEW TREATED WOOD NAILERS AND METAL COPING CAPS PER SPECIFICATIONS
- 11. PROVIDE NEW SHEET METAL SCUPPERS
- 12. CLEAR SCUPPERS OF DEBRIS AND ENSURE PROPER OPERATION.
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- 17. PROVIDE NEW CONCRETE SPLASH BLOCKS WHERE
- 18. NEW CRICKETS SIZE TO ENSURE PROPER DRAINAGE
- 19. PROVIDE NEW ROOF HATCH PROVIDE SUBMITTAL
- 20. PROVIDE NEW STEEL ROOF ACCESS LADDER PROVIDE SHOP DRAWING TO ARCHITECT SEE DETAIL 1/A1.5
- 21. REMOVE ALL MECH EQUIPMENT. PROVIDE NEW ROOFING AND FLASHING. REINSTALL ALL EQUIPMENT ON NEW CURB. PROVIDE MECHANICAL, PLUMBING AND MECHANICAL WORK AS REQUIRED TO REMOVE AND REINSTALL SYSTEM. VERIFY PROPER OPERATION AND STARTS UP.

GENERAL NOTES

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- C. ANY INCIDENTAL MECHANICAL. PLUMBING OR ELECTRICAL ASSOCIATED WITH ROOFTOP EQUIPMENT SHALL BE PERFORMED BY PROPER LICENSED SUBCONTRACTORS UNDER THIS ROOFING CONTRACT - ALL WORK SHALL BE PERFORMED TO CURRENT CODES
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- E. REMOVE EXISTING LOW VOLTAGE WIRE AND REINSTALL AFTER ROOF REPLACEMENT
- F. REMOVE AND PATCH ALL ABANDONED OPENINGS.
 NOTIFY ARCHITECT IF OPENING IS WIDER THAN 12'
 X 12"
- G. REMOVE AND REPLACE EXISTING LIGHTNING PROTECTION SYSTEM. NEW SYSTEM TO BE RE CERTIFIED
- H. DEMO ALL ABANDONED PITCH PANS. CAP WATER AND POWER

TYPICAL DETAILS THROUGHOUT

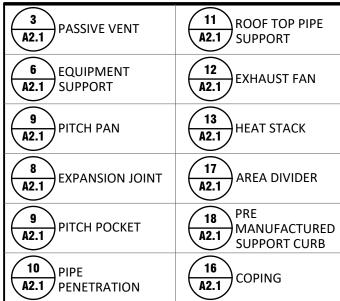

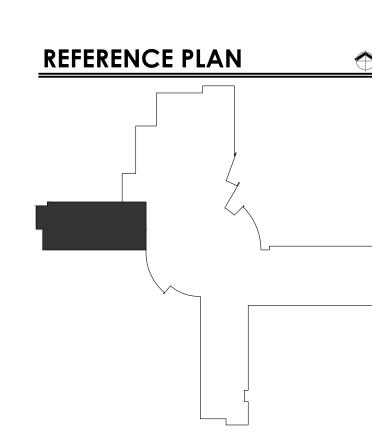

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602.347.5226

Washington **Elementary**

SCHOOL DISTRICT

CHECKED BY: L. LIND DATE: 10/12/21 NO. DATE COMMENT 12/27/22 ADDENDUM 01

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BUILDING C (SFB 1015) **ROOF PLAN**

